



LUTHERVILLE - BELLONA 1312 BELLONA AVENUE

SCALE

AS SHOWN

DATE

6/14/02

DESIGNED BY

DRAWN BY

CHK. BY

MCM PROJECT #


O2O2OA REVISIONS

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AUTOCAD FILE:



SCALE:1/8"=1'-0"

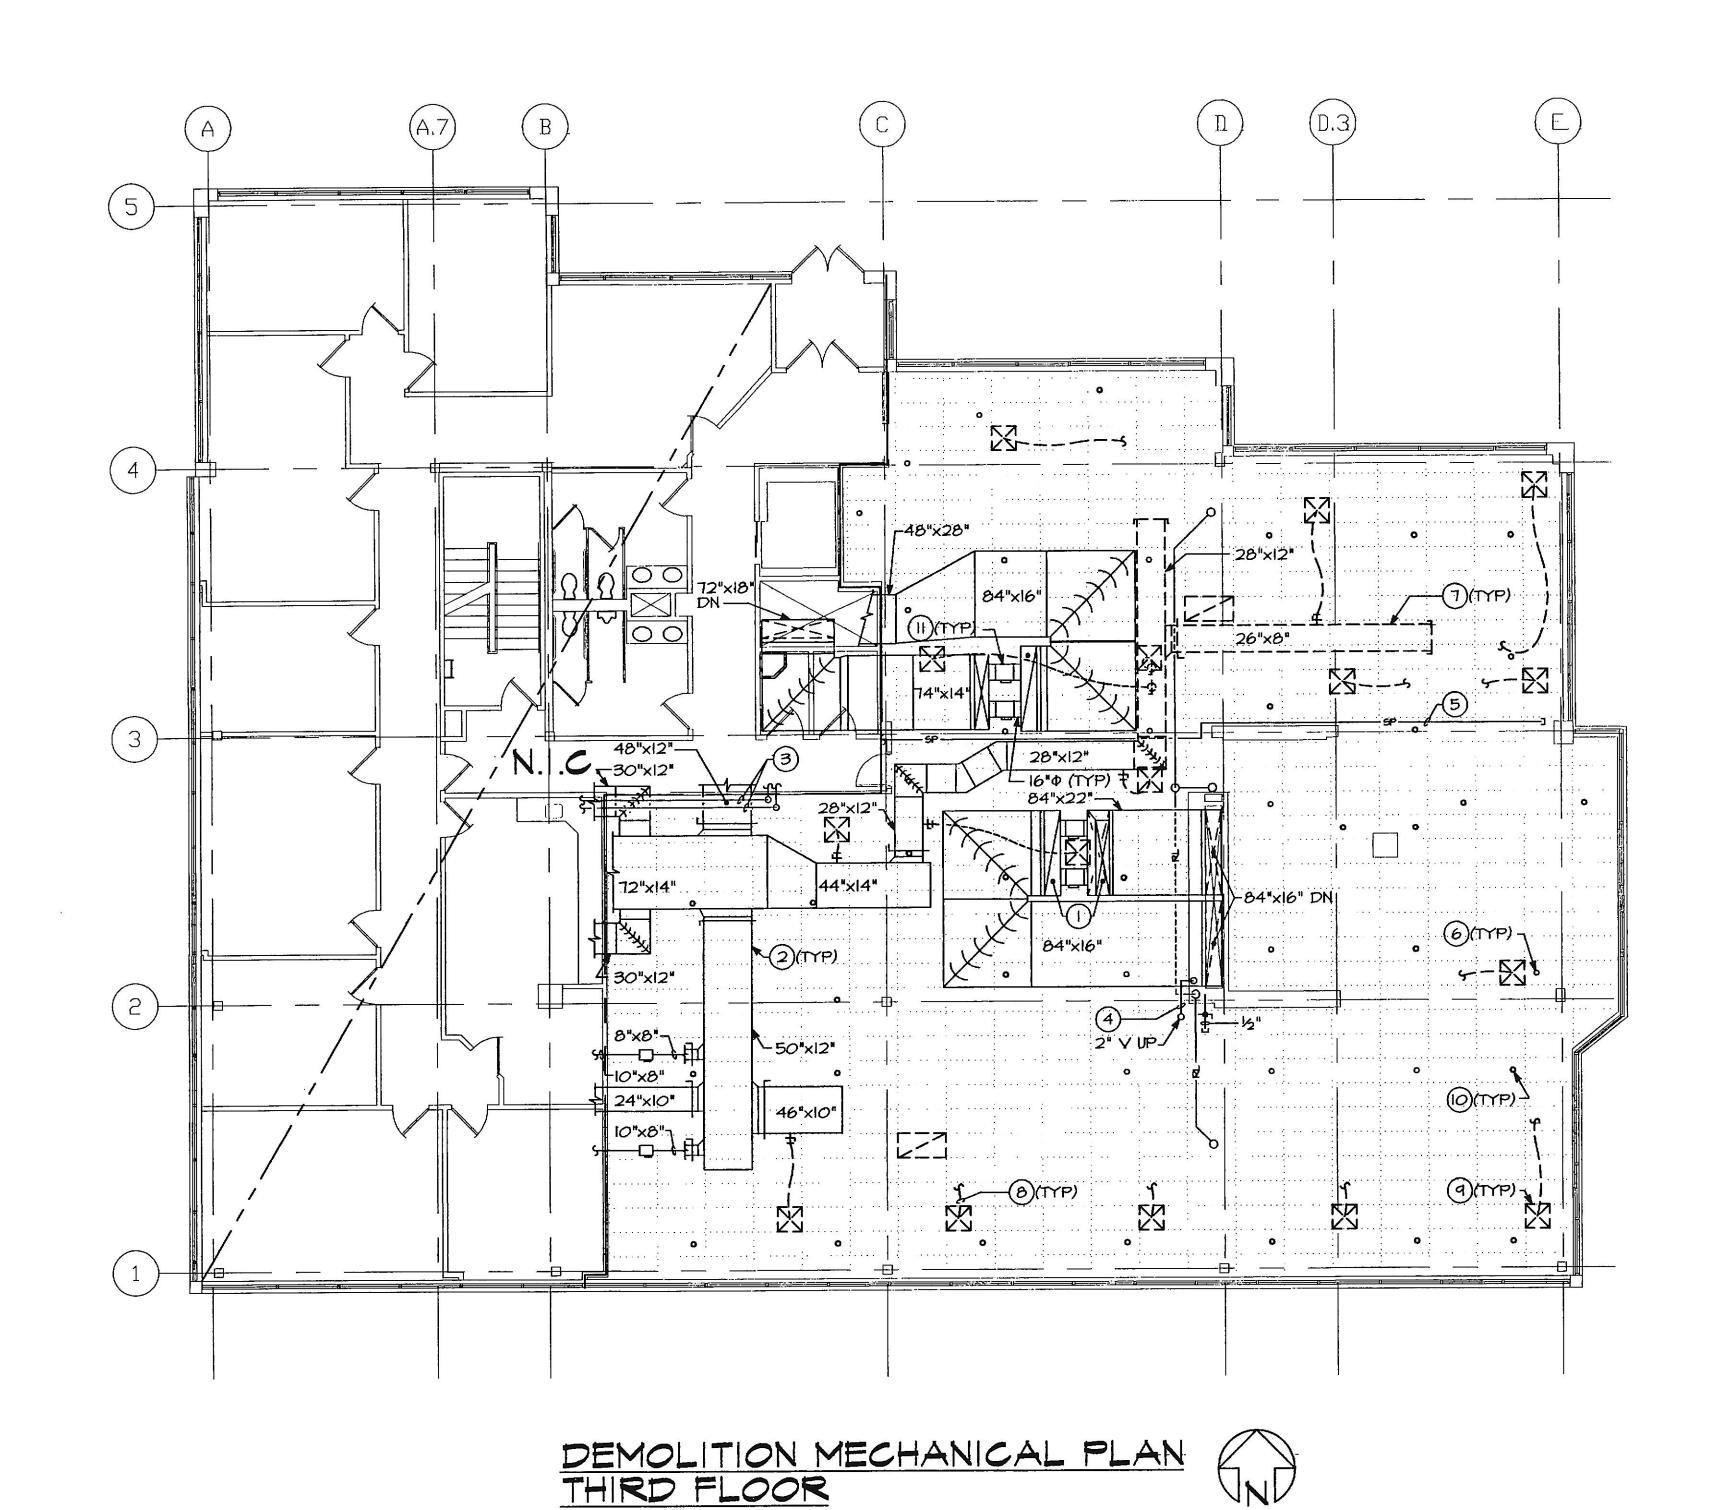

SCALE: 1/8" = 1'-0"

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## DRAWING NOTES

- () SUPPLY AND RETURN AIR DUCTS UP TO ROOFTOP UNIT TO REMAIN.
- 2 SUPPLY RETURN AIR DUCT TO REMAIN. CONTRACTOR SHALL VERIFY CONDITION OF EXISTING DUCTWRAP INSULATION. IF DETERMINED TO BE IN POOR CONDITION, THE CONTRACTOR SHALL REMOVE EXISTING INSULATION AND REINSULATE WITH MATERIAL AND THICKNESS AS INDICATED IN THE INSULATION SCHEDULE.
- (3) DOMESTIC WATER PIPING LOCATED ABOVE CEILING TO REMAIN.
- (4) VENT PIPING LOCATED ABOVE CEILING IN CHASE AREA TO REMAIN.
- 5) APPROXIMATE ROUTING OF SPRINKLER MAIN PIPING LOCATED ABOVE CEILING TO REMAIN.
- (6) SPRINKLER HEAD TO REMAIN.
- (7) REMOVE SUPPLY AIR DUCTWORK TO EXTENT SHOWN.
- (8) REMOVE FLEX DUCT RUNOUT AS SHOWN.
- (9) REMOVE AIR DEVICE AS SHOWN.
- REMOVE/RELOCATE SPRINKLER HEAD. REFER TO MECHANICAL PLAN THIRD FLOOR, SHEET M4, FOR NEW LOCATION.
- (I) BYPASS DAMPER CONTROLS AND ACCESSORIES TO REMAIN.