




NOTE:
PROVIDE FIN LP SURFACES ON EXPOSED ENDS OF BASE AND WALL CASES.

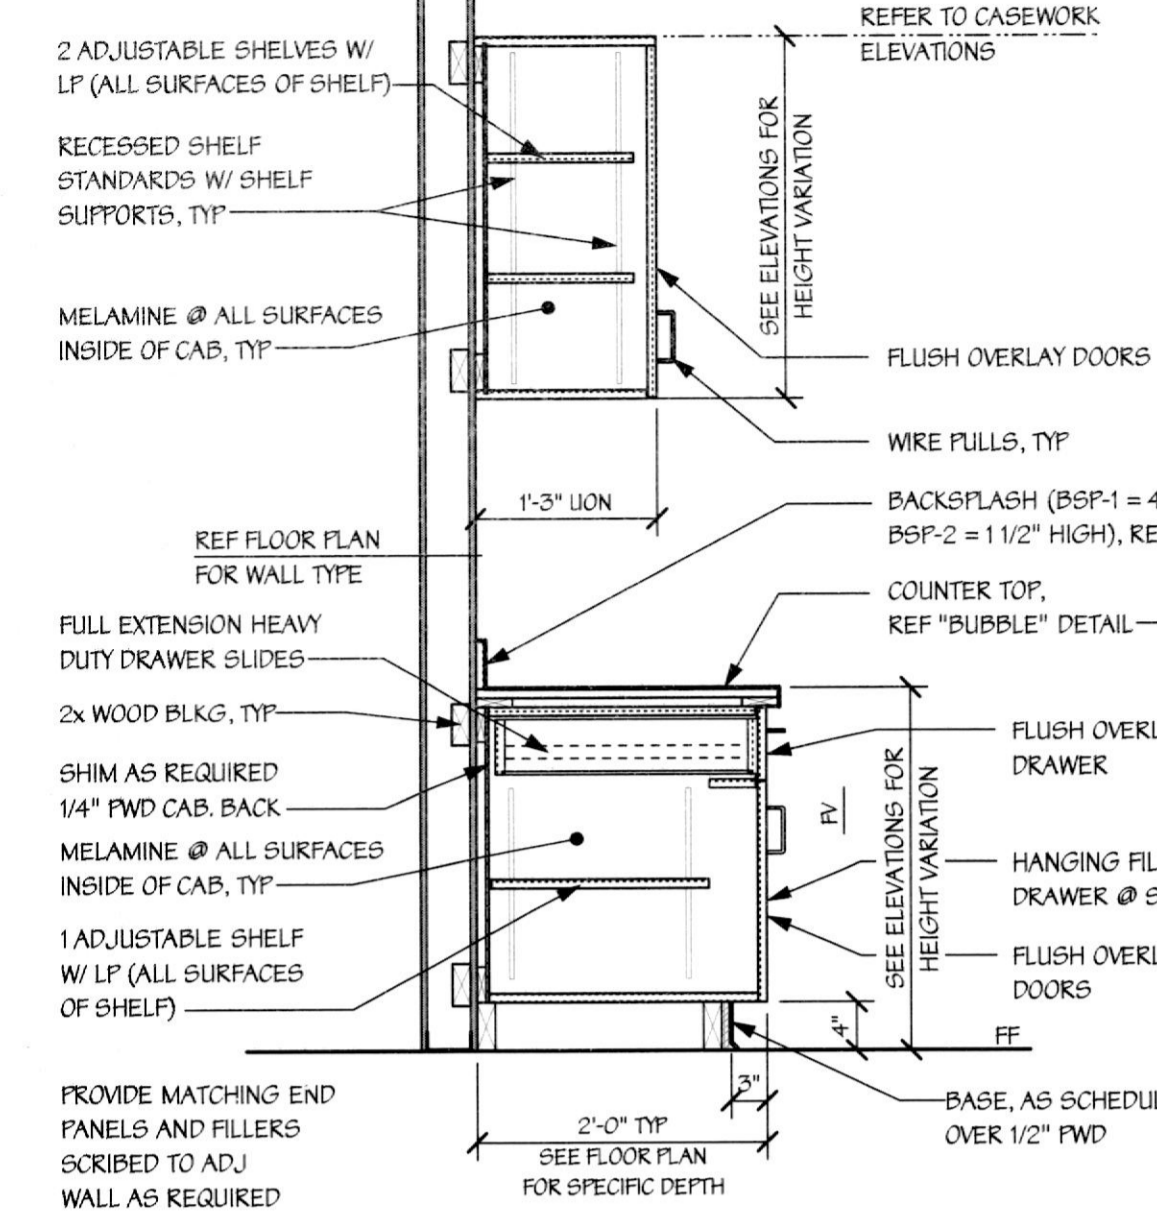


3B TYPICAL CASEWORK SECTION
Scale: 3/4" = 1'-0"

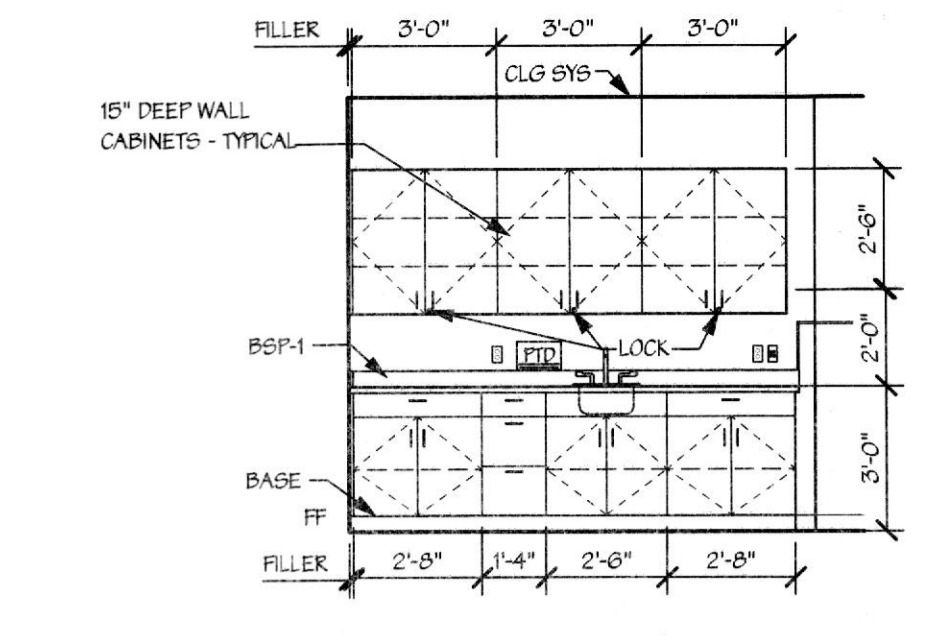


2B 209 CLEAN PREP ROOM
Scale: 1/4" = 1'-0"

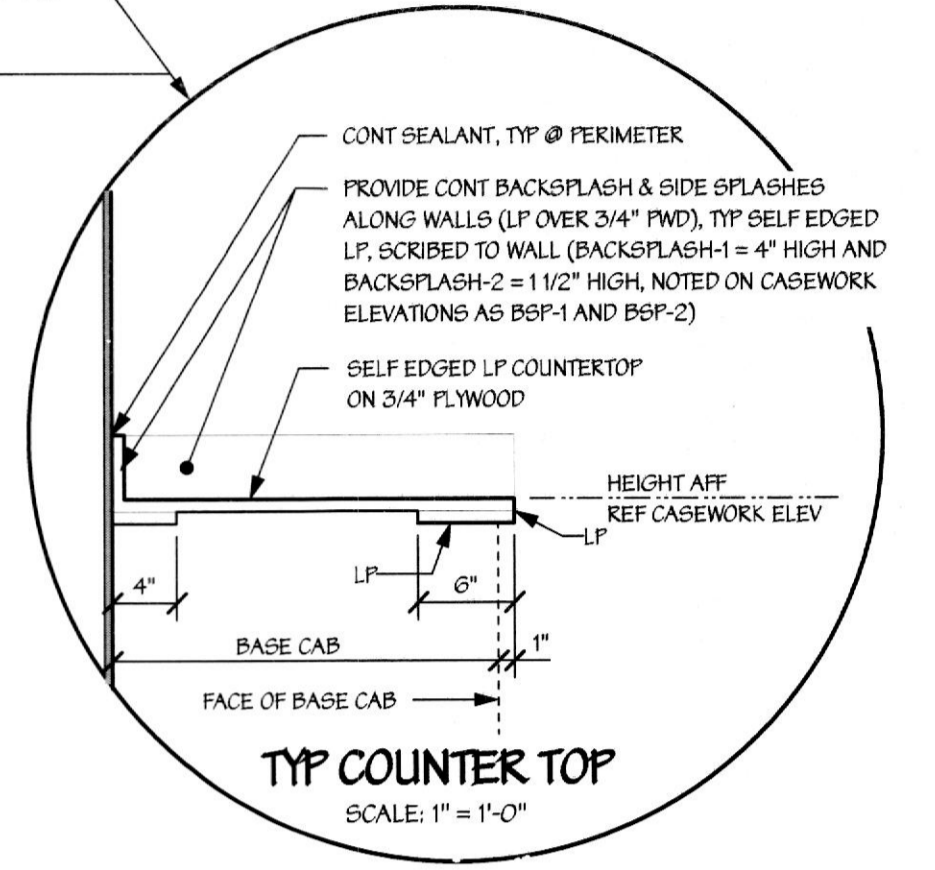


A2 TYP. COUNTER TOP
Scale: 1" = 1'-0"

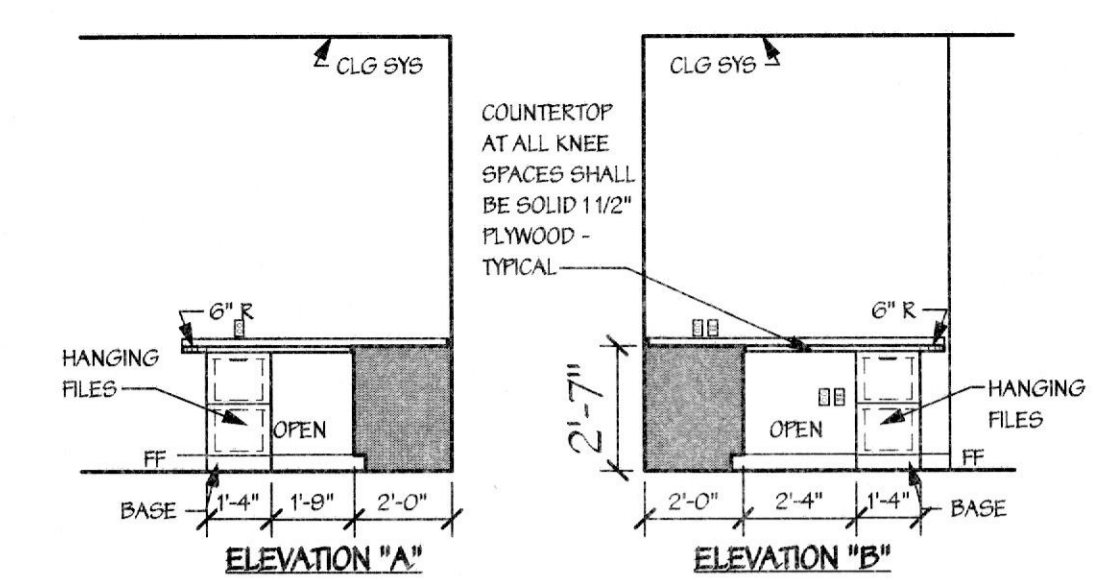

2C 201 WORK AREA
Scale: 1/4" = 1'-0"

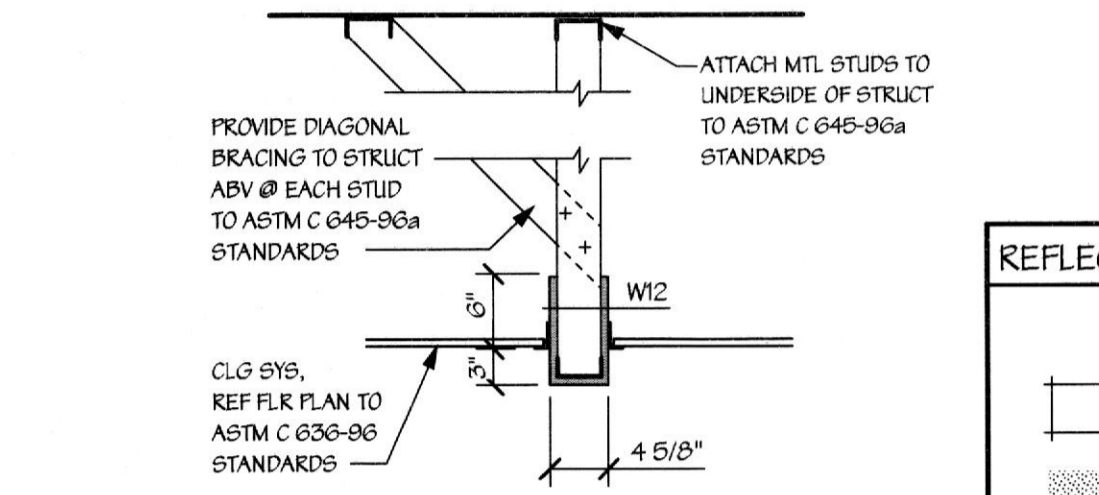

3C TYPICAL BULKHEAD DETAIL
Scale: 3/4" = 1'-0"

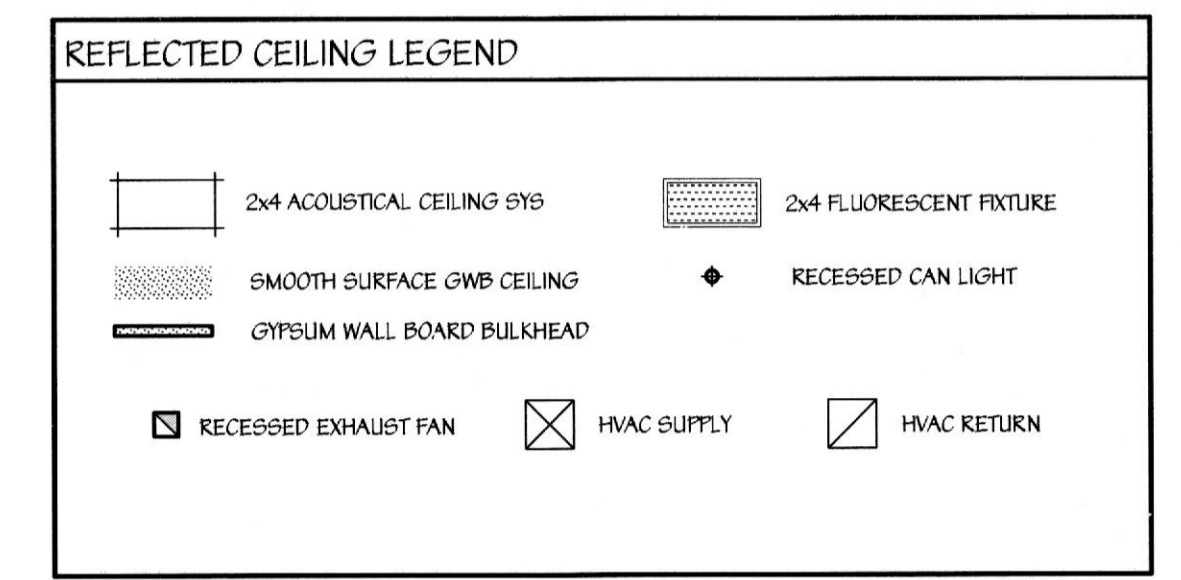

3F REFLECTED CEILING PLAN
Scale: 1/8" = 1'-0"

INFECTION CONTROL GENERAL NOTES


- 1. TEMPORARILY SHUT-OFF SUPPLY AND RETURN AIR IN WORK AREA DURING CONSTRUCTION.
- 2. TEMPORARILY BLANK-OFF ALL RETURN AIR REGISTERS WITHIN THE WORK AREA.
- 3. PROVIDE EXHAUST AIR IN AREAS OF NEW WORK TO EXTERIOR. PROVIDE FILTERED MEDIA AT NEGATIVE AIR EXHAUST. COORDINATE WITH OWNER AND LANDLORD

INFECTION CONTROL NOTES


- 1. INITIAL CONSTRUCTION SITE CONTAINMENT WILL BE IMPLEMENTED PRIOR TO PROJECT COMMENCEMENT BY GENERAL CONTRACTOR. THE CONTRACTOR SHALL MAINTAIN THE CONSTRUCTION SITE CONTAINMENT DURING CONSTRUCTION OF EACH AREA OF WORK.
- 2. FOR WORK ABOVE CEILING, OUTSIDE OF CONTAINMENT AREA, PROVIDE ISOLATION MEASURES TO SEPERATE WORK AREA FROM ADJACENT SPACES. MAINTAIN 3' - 8" WIDE MINIMUM EGRESS PATH AT ALL TIMES.
- 3. COORDINATE WITH OWNER AND LANDLORD THE CONTRACTOR'S MEANS AND METHODS PROPOSED TO MAINTAIN NEGATIVE PRESSURE IN WORK AREAS.

DEMOLITION NOTES


- 1. DESIGNATES A DEMOLITION NOTE THAT CORRESPONDS TO THE NOTES BELOW.
- 1. PROVIDE A HEAVY DUTY POLY TEMPORARY DUST PARTITION TAPED TO SURROUNDING SURFACES AT ALL TIMES DURING WORK IN THIS AREA. CLEAN WORK AREA BEFORE REMOVING POLY DUST PARTITION.
- 2. PROVIDE DUST PARTITION PER DETAIL 7B/A2 TO ENCLOSE THE CONSTRUCTION AREA. CONTRACTOR SHALL INSTALL DOOR THROUGH DUST PARTITION IN A LOCATION THAT IS BEST SUITED FOR THE WORK AND TO PROVIDE EGRESS THROUGH THIS AREA. CONTRACTOR TO MAINTAIN EGRESS PATH AT ALL TIMES. PROVIDE DUST MATS OUTSIDE DOOR AND REPLACE AS NEEDED TO KEEP CONSTRUCTION DUST FROM LEAVING THIS AREA.
- 3. SEAL DOOR DURING WORK IN THIS AREA / ROOM.
- 4. CAREFULLY REMOVE EXISTING DOOR/ HARDWARE AND FRAME FOR REUSE. PREPARE OPENING FOR NEW INFILL WORK AS APPLICABLE. REFER TO FOLLOWING SUFFIN AND FLOOR PLAN FOR INTENDED RELOCATION OF THIS DOOR AND HARDWARE. NOTE THAT MOST, BUT NOT ALL HARDWARE STAYS WITH THE EXISTING DOOR. HARDWARE THAT IS RELOCATED / REWORKED TP BE USED ON ANOTHER DOOR MAY NOT WORK WITH SWING/HAND OF DOOR IN THE NEW LOCATION. CONTRACTOR TO COORDINATE EXISTING CONDITIONS WITH NEW CONDITIONS AND REPLACE ANY REQUIRED HARDWARE WITH MATCHING NEW HARDWARE IF EXISTING HARDWARE WILL NOT FUNCTION PROPERLY. FRAMES SHALL BE REPAINTED AND DOORS SHALL BE TOUCHED UP AS NEEDED TO CREATE A "LIKE NEW" APPEARANCE. THE FOLLOWING SUFFINS PROVIDE ADDITIONAL INFORMATION FOR EACH DOOR.
01 DOOR TO BE RELOCATED. SEE DOOR 207. EXISTING HARDWARE TO BE RELOCATED. SEE DOOR 204. SEE EXISTING DOOR 06 FOR RELOCATED/REUSED/REWORKED HARDWARE FOR THIS DOOR IN NEW LOCATION.
02 DOOR AND HARDWARE TO BE RELOCATED. SEE DOOR 202a.
03 DOOR TO BE RELOCATED. SEE DOOR 202b. EXISTING HARDWARE NOT REUSED. SEE EXISTING DOOR 05 FOR RELOCATED/REUSED/REWORKED HARDWARE FOR THIS DOOR IN NEW LOCATION.
04 DOOR AND HARDWARE TO BE RELOCATED. SEE DOOR 201.
05 DOOR TO BE RELOCATED. SEE DOOR 204. EXISTING HARDWARE TO BE RELOCATED. SEE DOOR 202b.
06 EXISTING DOOR 01 FOR RELOCATED/REUSED/REWORKED HARDWARE FOR THIS DOOR IN NEW LOCATION.
08 DOOR TO BE RELOCATED. SEE DOOR 121. EXISTING HARDWARE TO BE RELOCATED. SEE DOOR 207. SEE EXISTING DOOR 07 FOR RELOCATED/REUSED/REWORKED HARDWARE FOR THIS DOOR IN NEW LOCATION.
07 DOOR TO BE REMOVED BUT NOT RELOCATED. EXISTING HARDWARE TO BE RELOCATED. SEE DOOR 121.
09 DOOR AND HARDWARE TO BE RELOCATED. SEE DOOR 205a.
09 DOOR AND HARDWARE TO BE RELOCATED. SEE DOOR 203.
10 DOOR AND HARDWARE TO BE RELOCATED. SEE DOOR 211.
11 DOOR AND HARDWARE TO BE RELOCATED. SEE DOOR 120.
- 5. REMOVE PORTION OF EXISTING WALL TO CREATE AN OPENING FOR THE NEW DOOR AND FRAME IN THIS AREA. COORDINATE LIMITS WITH FLOOR PLAN.
- 6. REMOVE EXISTING WALLS IN THIS AREA. COORDINATE LIMITS WITH FLOOR PLAN.
- 7. REFER TO ELECTRICAL DRAWINGS FOR RELOCATION OF EXISTING ELECTRICAL PANEL.
- 8. REMOVE EXISTING CASEWORK AND ASSOCIATED PLUMBING. CAP PLUMBING.
- 9. REMOVE EXISTING FLOORING AND CEILING IN THIS AREA AND PREPARE FOR INSTALLATION OF NEW FINISHES. CAREFULLY COORDINATE THE LIMITS OF WORK WITH FLOOR PLAN AND CEILING PLAN.
- 10. REMOVE EXISTING STEPS IN THIS AREA AND REWORK TO ACCOMMODATE NEW WORK.
- 11. REMOVE EXISTING WALL GUARDS IN THIS AREA. PREPARE WALLS FOR NEW FINISHES.
- 12. CAREFULLY REMOVE EXISTING WALL PROTECTION IN THIS AREA TO ACCOMMODATE NEW WORK. REFER TO FLOOR PLAN FOR NEW WORK, INCLUDING REWORKING OF THE EXISTING WALL PROTECTION TO REMAIN.
- 13. REMOVE EXISTING CORNER GUARDS AND REWORK EXISTING BULKHEAD TO ACCOMMODATE NEW WORK.

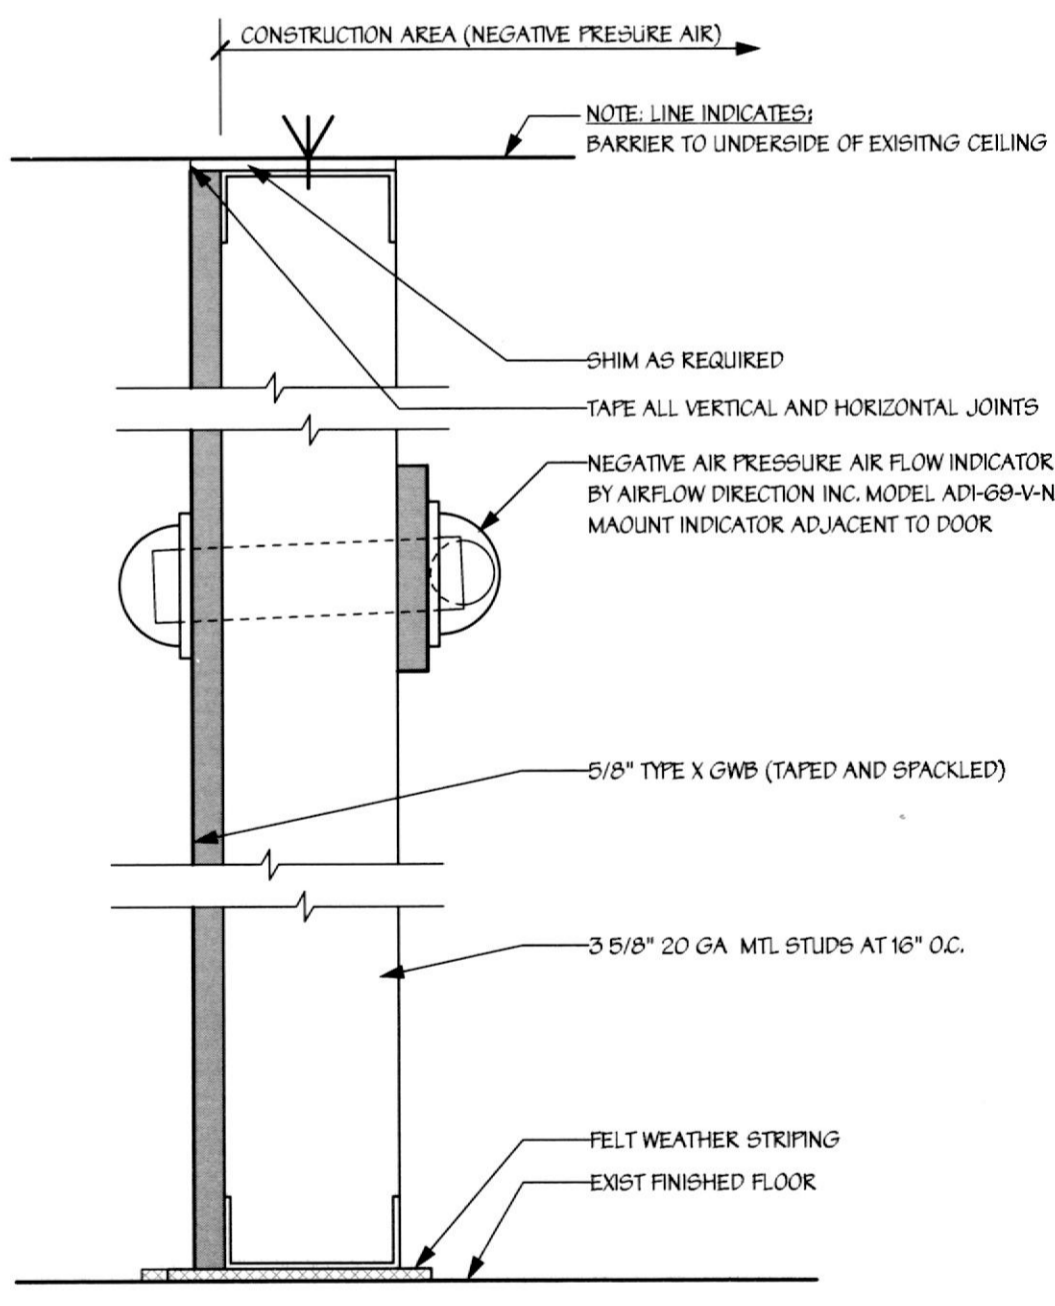


7B TYPICAL DUST PARTITION DETAIL
Scale: 3" = 1'-0"

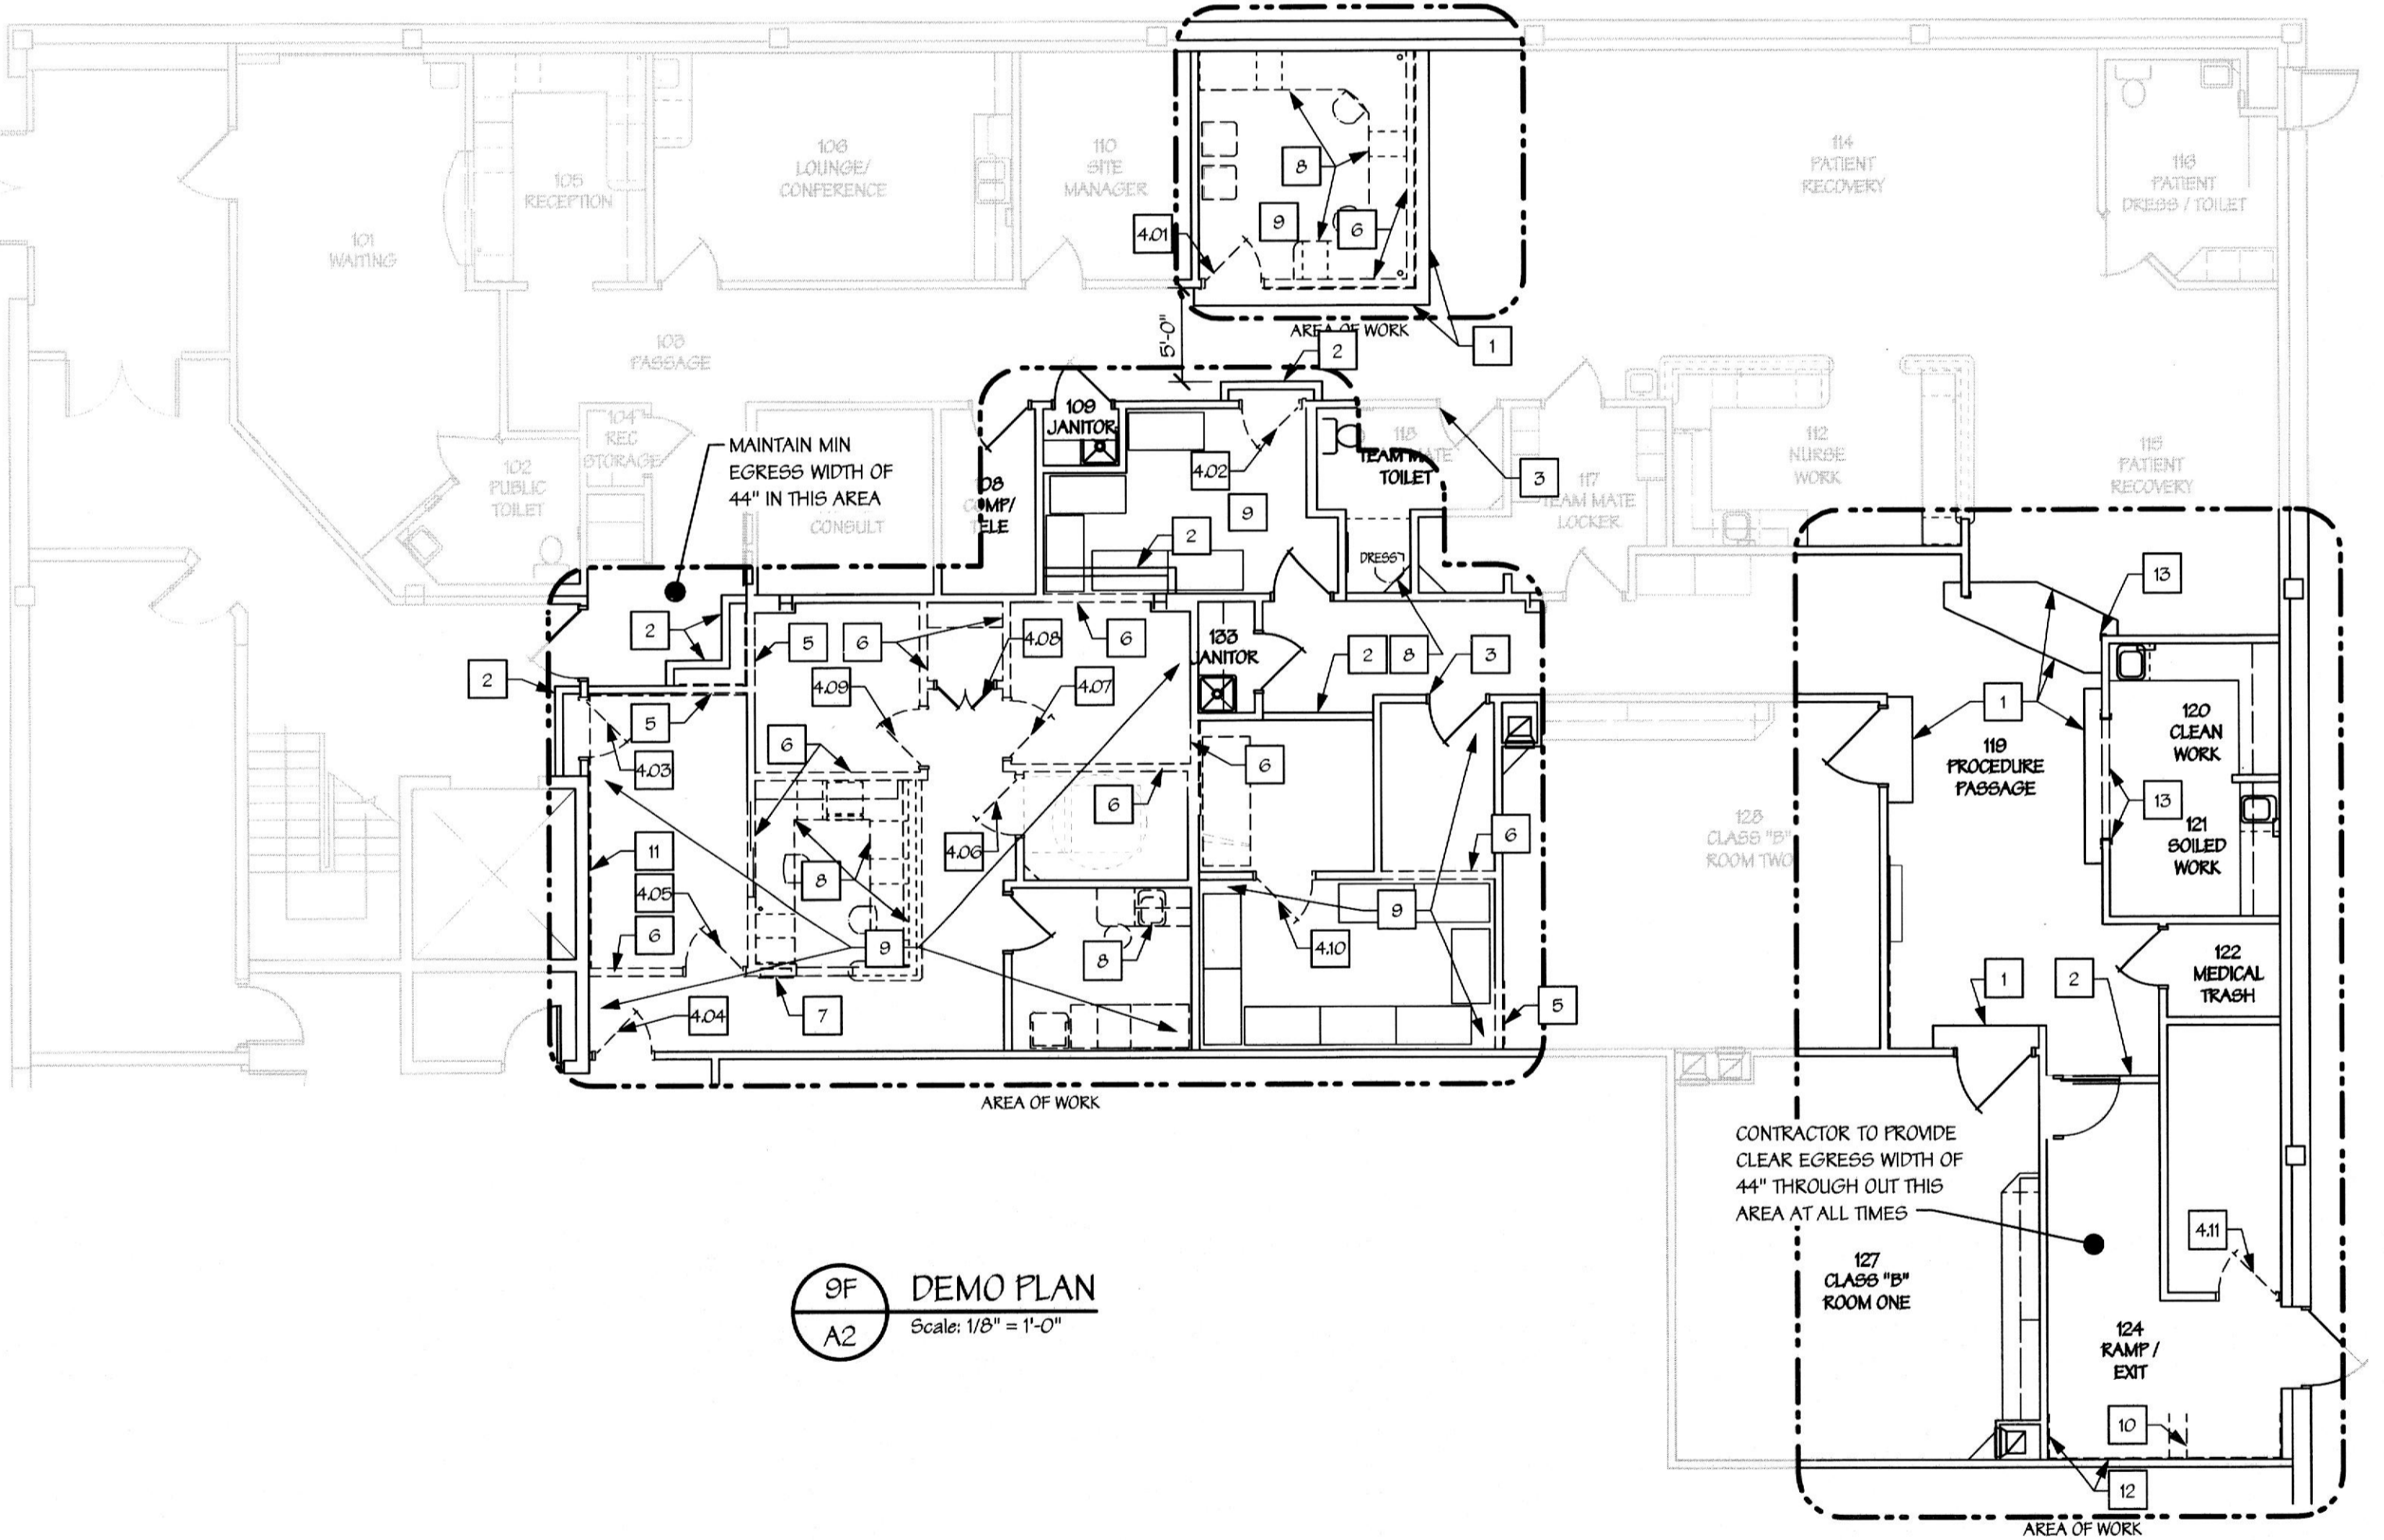


9F DEMO PLAN
Scale: 1/8" = 1'-0"

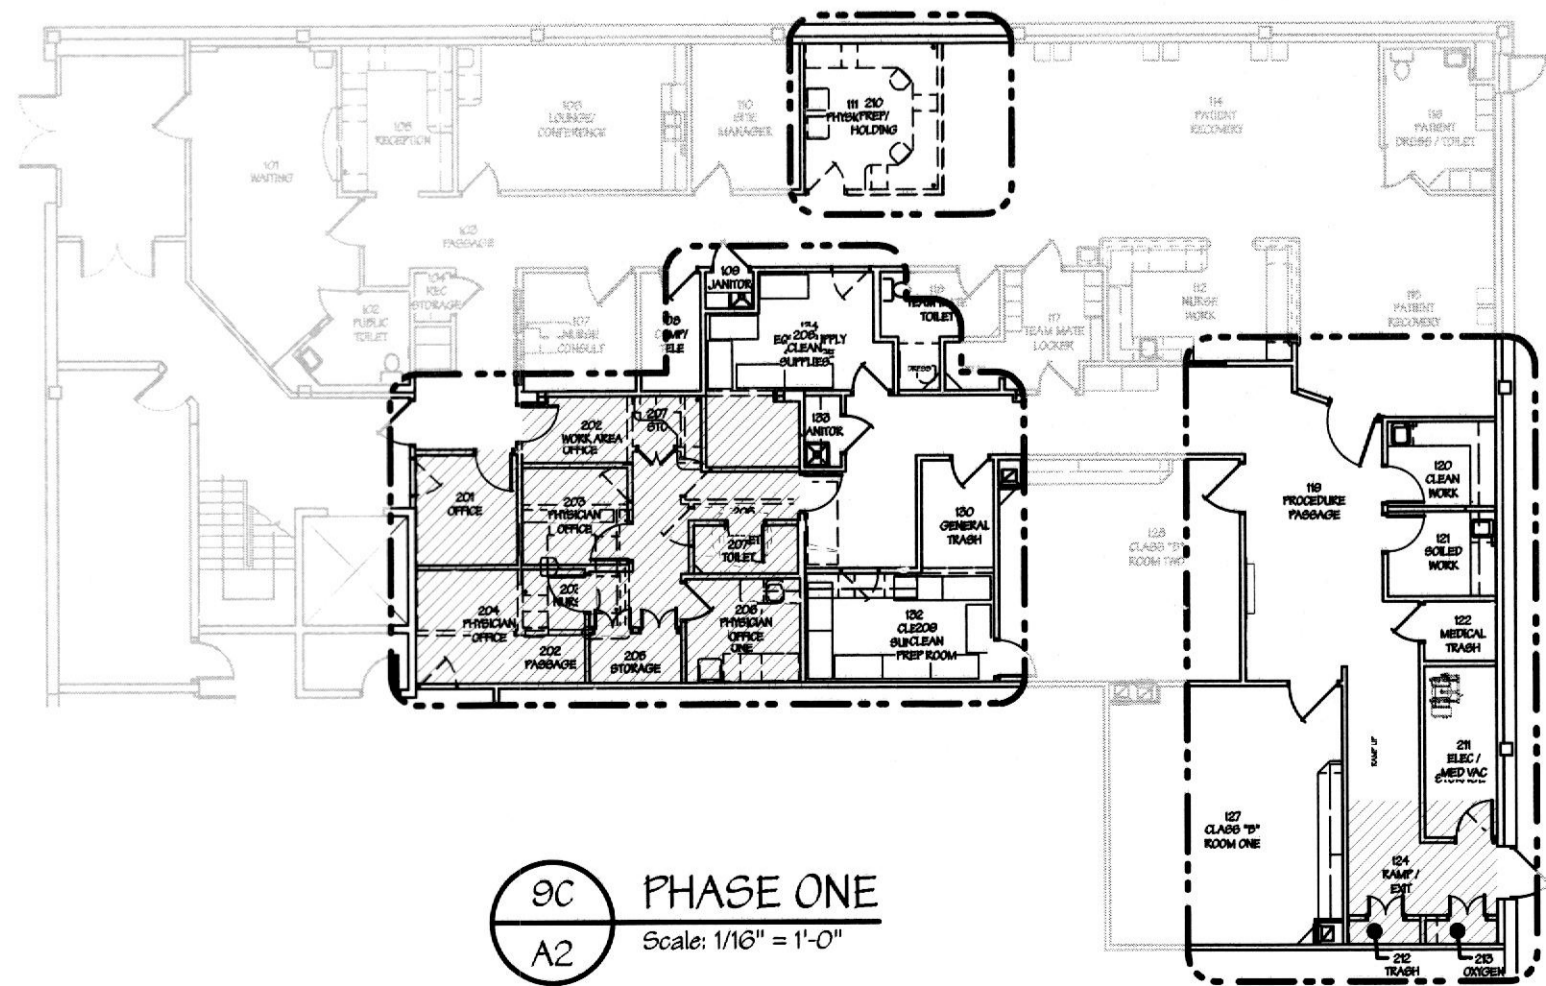

9C PHASE ONE
Scale: 1/8" = 1'-0"

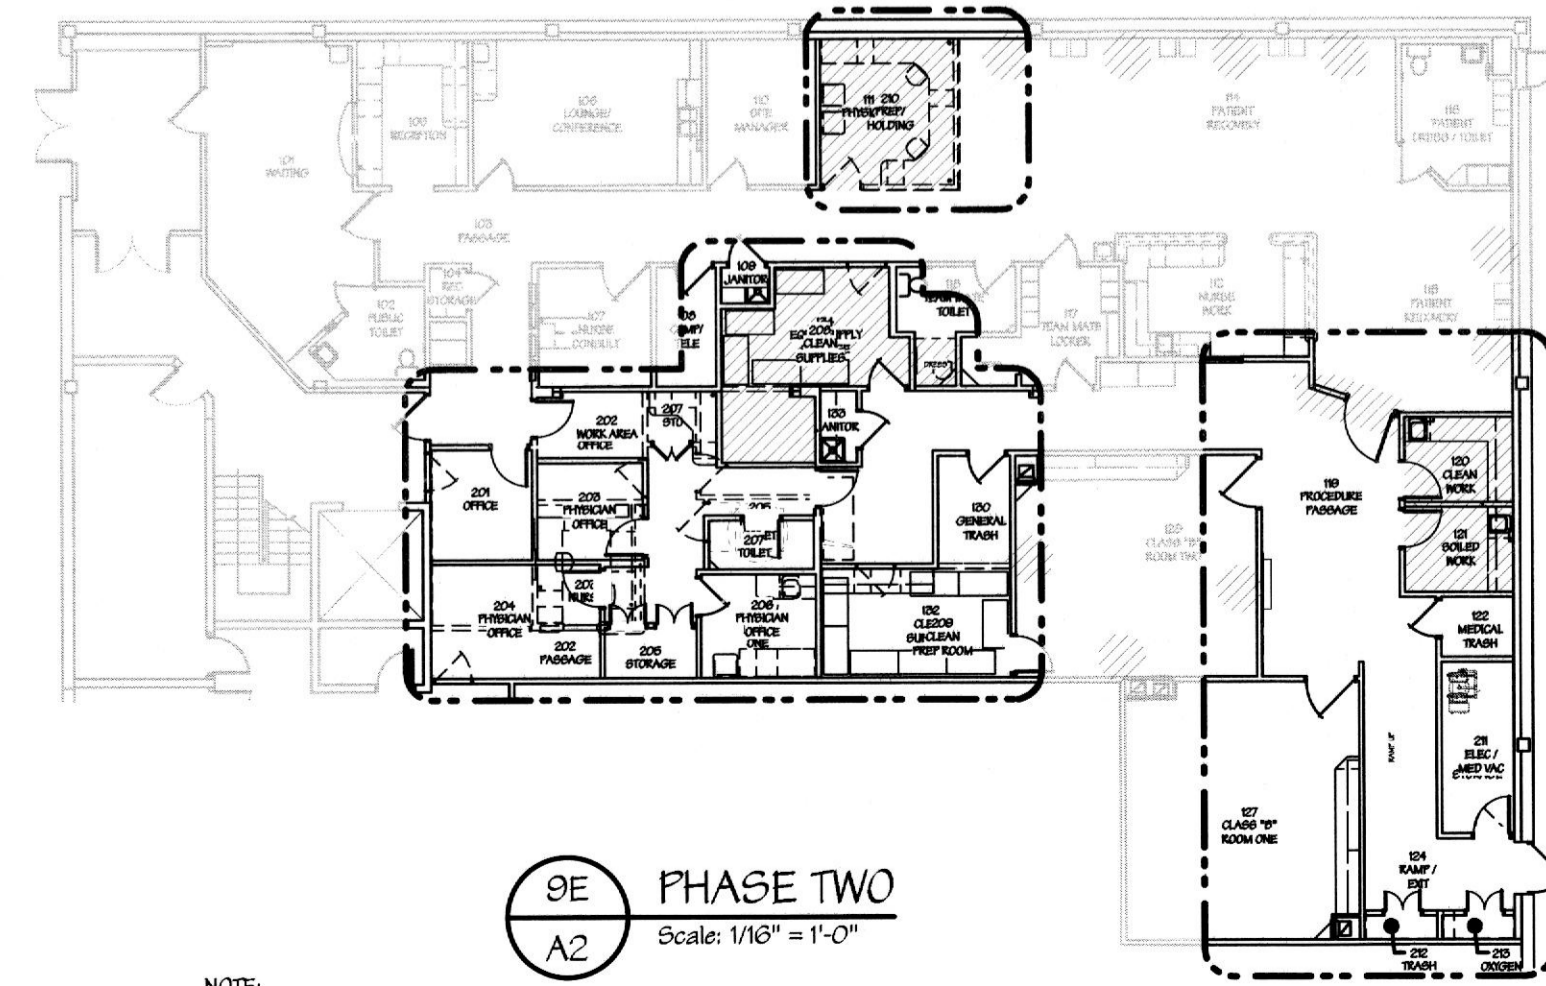

9E PHASE TWO
Scale: 1/8" = 1'-0"

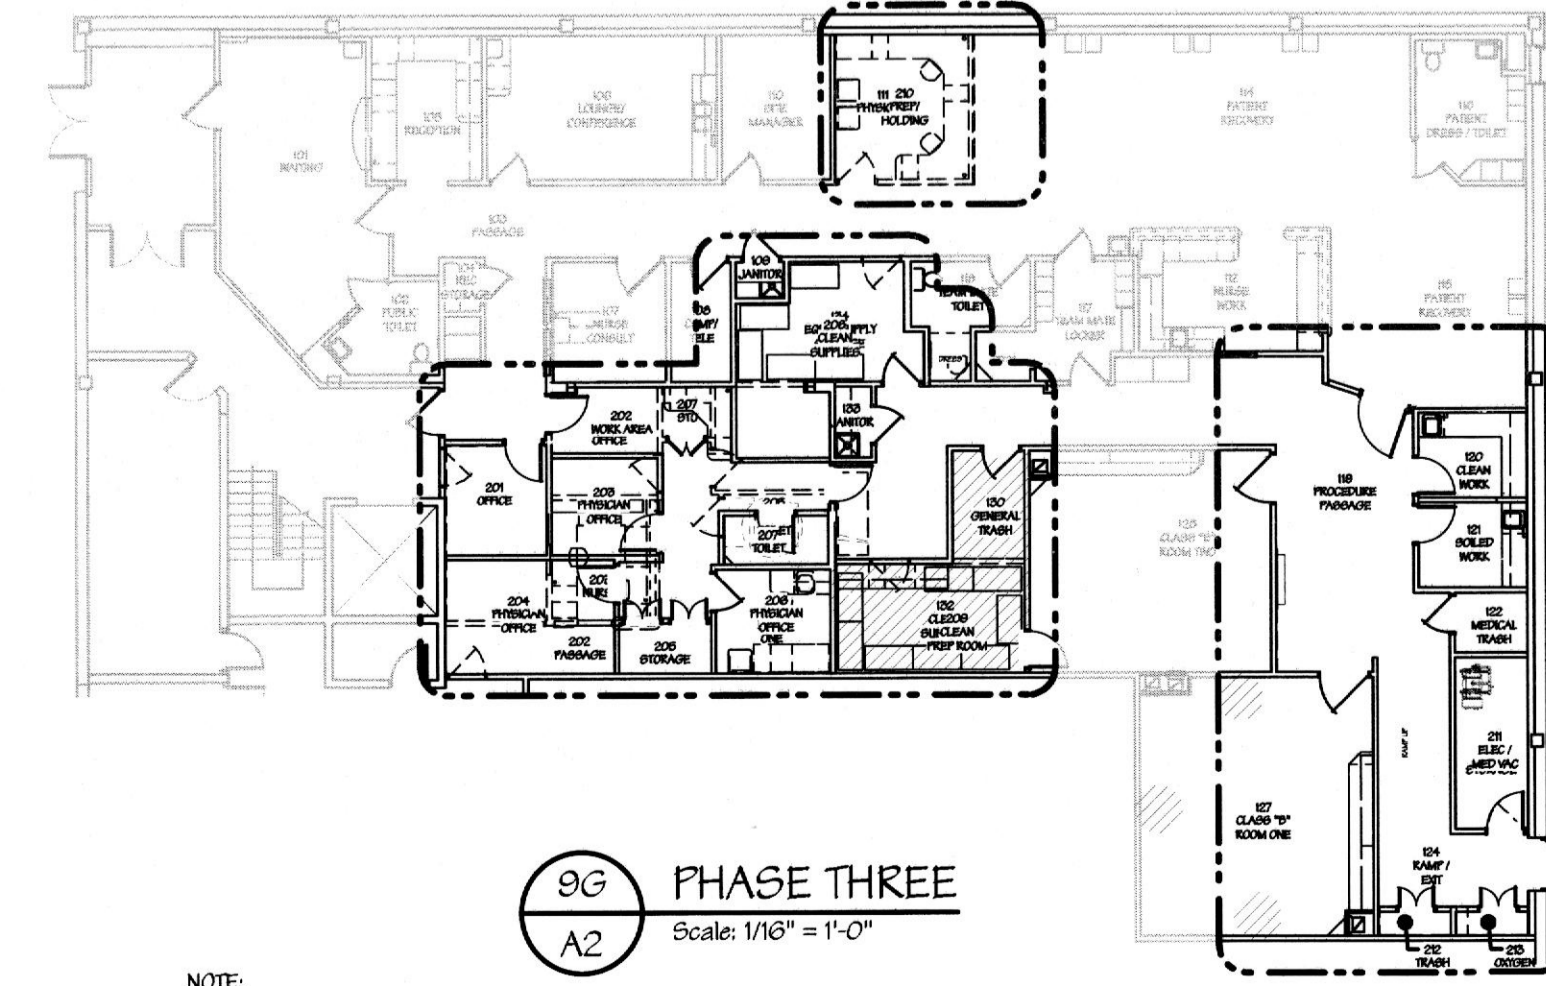

9G PHASE THREE
Scale: 1/8" = 1'-0"

NOTE:
TO THE GREATEST EXTENT POSSIBLE, WORK IN THESE AREAS SHALL BE CONFINED TO NIGHTS AND WEEKENDS. CONTRACTOR SHALL TAKE EVERY EFFORT TO PROVIDE THE OWNER ACCESS TO SURROUNDING AREAS DURING BUSINESS HOURS. COORDINATE WITH OWNER.

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NOTE: CONTRACTOR AND SUB-CONTRACTORS SHALL VISIT THIS BUILDING AND TENANT AREA AND BE FAMILIAR WITH ALL THE EXISTING CONDITIONS PRIOR TO CONTRACT AWARD

Scale bar: 0' 1' 2' 8'
1/8"=1'-0" 8' 16' 24'
1/4"=1'-0" 4' 8' 12'

REVISIONS	
REV#	DESCRIPTION

REGISTERED ARCHITECT
STATE OF NEW YORK
1925/27

In Sync
ARCHITECTURAL DESIGNS, INC.
1215 Old Ryerlands Road
Whiteford, MD 21160
Office: 410-462-8046

REGISTERED ARCHITECT
STATE OF NEW YORK
1925/27

ISSUED FOR BUILDING PERMIT

DON PEIN CONSULTING ENGINEER
1301 SOLANA BLVD.
BLDG 71 SUITE 1420
WESTLAKE, TX 76062
O 817.410.2888 | F 817.251.8411

cpce

TENANT RENOVATIONS FOR:
Access Center
1733 Eastchester Road
Bronx, NY 10461

Lifeline
Vascular Access

DRAWING NO: A-102.00
SHEET OF
DATE: 10/20/17
JOB NO: 111-2017
11/21/17