DOMESTIC WATER PIPING

REVISIONS DRAWING NO. P-104.00

PLUMBING FIXTURE

SPECIFICATIONS

GENERAL NOTES:

1. ALL SINKS: ALL EXPOSED BEND SPOUT, 8" TRIM PLATE AND WASTE PIPING AND HOT AND PLUG-IN TRANSFORMER. FAUCET COLD WATER PIPING SHALL BE INSULATED WITH
TRUEBRO HANDI LAV-GUARD
MODEL 102 INSULATION KIT

WITH WHITE FINISH. 2. BACKFLOW PREVENTERS (VACUUM BREAKERS) SHALL BE INSTALLED ON ALL CLINICAL SINKS, JANITOR SINKS, HOSE BIBBS ETC. AND ON ALL OTHER FIXTURES TO WHICH HOSES

AND TUBING CAN BE ATTACHED. 3. BACKFLOW PREVENTION SHALL BE INSTALLED FOR ALL REFRIGERATOR ICE MAKER CONNECTIONS

P-1 COUNTERTOP EXAM SINK:

#LR-1722 BY ELKAY, 18 GAUGE—TYPE 301—SELF RIM BOWL. FAUCET SHALL BE #27T2944 BY DELTA, 10-1/2" HIGH GOOSENECK SPOUT WITH 6" WRIST BLADE HANDLES AND A 1.5 GPM LAMINAR FLOW WITH AERATOR. SINK TO BE COMPLETE WITH GRID DRAIN, TAILPIECE, AST BRASS "P" TRAP, WALL ESCUTCHEON AND SUPPLY VALVES WITH CHROME SUPPLIES.

P-2 SCRUB SINK: #Z5460 BY ZURN, (NO SUBSTITUTES), WALL MOUNTED

VITREOUS CHINA SURGEON SINK, LOW FRONT RIM WITH LARGE DEEP BASIN, SINGLE FAUCET HOLE, COMPLETE WITH CONCEALED FLOOR MOUNTED ARM CARRIER/SUPPORT BRACKETS. FAUCET SHALL BE POLISHED CHROME PLATED SENSOR ACTIVATED, SOLIDE BRASS SOLENOID WITH BUILT-IN FILTER SOLENOID VALVE WITH SERVICABLE "Y" STRAINER FILTER AND 2.2 GPM LAMINAR FLOW. METAL JACKETED WIRE

PROTECTION FOR SENSOR AND


SOLENOID LEADS. GOOSENECK FAUCET SHALL HAVE A SURGICAL SLOAN, MODEL #ETF-700-S-8P NO SUBSTITUTIONS. SINK TO BE COMPLETE FLAT METAL DRAIN WITH 1-1/2"X4" TAILPIECE. ALSO INCLUDE P TRAP, TUBING TO WALL ESCUTCHEON AND SUPPLY VALVES WITH CHROME SUPPLIES.

P-3 SHOWER: CRANE MODEL 3636.01F R
WITH 36"X36" STALL, ONE—PIECE
FIBERGLASS CONSTRUCTION.
UNIT SHALL COME WITH FACTORY OPTION, CAST BRASS DRAIN WITH CHROME PLATED STRAINER,
ACRYLIC ANTIBACTERIAL
PROTECTION, WHITE FINISH,
SHOWER CURTAIN, SOLID PADDED

VINYL SEAT, SLIDE GUIDE (FOR HAND HELD SHOWER ATTACHMENT), SWIVEL FITTING, 69" FLEXIBLE STAINLESS STEEL HOSE, AND IN-LINE
BREAKER AND PRESSURE
BALANCED SINGLE LEVER MIXING VALVE WITH CHECK STOPS.

TMV-1 FOR ALL SINKS (EXCEPT SCRUB SINK) SHALL BE SYMMONS MAXLINE MODEL #5-210-CKX-NI THERMOSTATIC MIXING VALVE WITH %" INLET AND OUTLET, WITH COMPRESSION
FITTINGS, BRASS / BRONZE
BODY, STAINLESS STEEL FLOW CONTROL COMPONENTS, VANDAL RESISTANT LOCKABLE HANDLE, SEPERATE CHECKS, WALL BRACKET, ROUGH CHROME FINISH. ASSE 1070 CERTIFIED. FIELD SET

 $\underline{\mathsf{TMV}} - \underline{\mathsf{2}}$ for scrub sink. SHALL BE BRADLEY MODEL S59-2005 PRESSURE BALANCED ANTI-SCALD VALVE MOUNTED ON WALL 4" ABOVE SCRUB SINK ON THE RIGHT HAND SIDE OF THE SINK. ANTI-SCALD VALVE TO WORK IN CONJUNTION WITH INFRA-RED GOOSENECK FAUCET

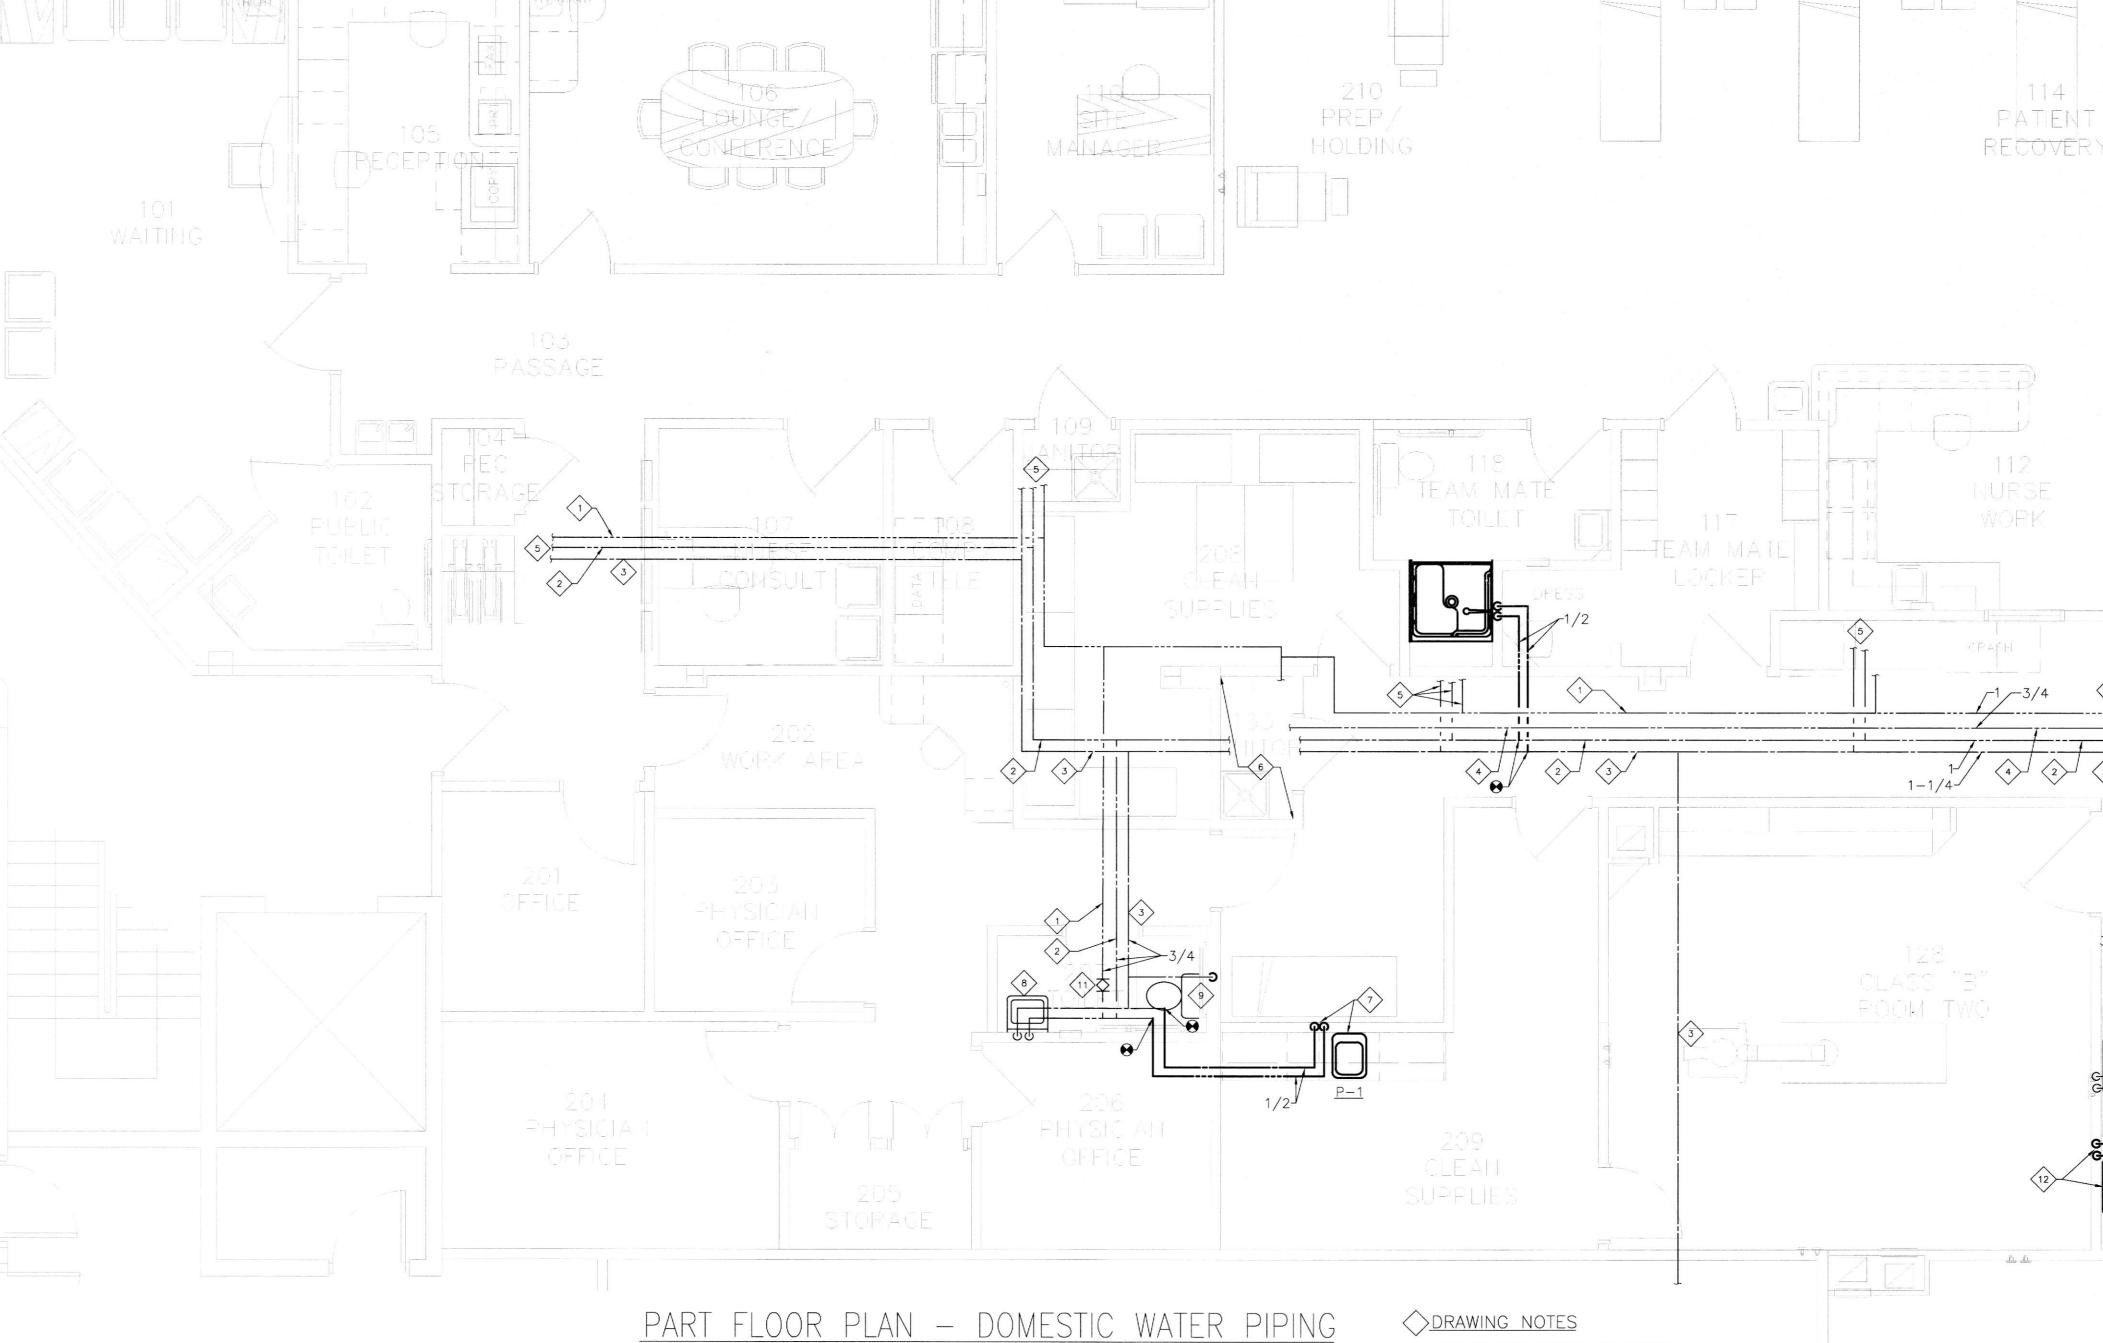

PLUMBING FIXTURE SCHEDULE ROUGH IN PIPE CONNECTION SIZES NPS FIXTURE TAG# DESCRIPTION COUNTERTOP EXAM SINK SURGEON SCRUB SINK P-3 SHOWER NOTES 1 REFER TO SPECIFICATIONS FOR FURTHER DETAILS

SCHEMATIC NOTES 1. ALL PIPE SIZES NOTED ARE IN INCHES
2. PROVIDE STOP VALVES AT EACH FIXTURE THERMOSTATIC MIXING VALVE TMV-1 4. THERMOSTATIC MIXING VALVE TMV-2 DRAWING NOTES DETAIL-A <u>DETAIL-B</u> NO SCALE

1/4" = 1'-0"

ETR RE-CIRCULATING HOT WATER

2. ETR 110 F DOMESTIC HOT WATER

3. ETR DOMESTIC COLD WATER 4. ETR 140 F DOMESTIC HOT WATER

5. ETR DOMESTIC WATER PIPING TO EXISTING **FIXTURES**

6. ETR WH IN THIS ROOM. ETR ALL PIPING IN THIS ROOM

7. NEW CLINICAL SINK. PIPE $\frac{1}{2}$ " CW AND $\frac{1}{2}$ " HW DOWN IN WALL CAVITY TO SINK. PROVIDE THERMOSTATIC MIXING VALVE. REFER TO PIPING DETAIL A

8. ETR LAVATORY 9. ETR TOILET

10. ETR SCRUB SINK

11. ETR BALANCING VALVE

12. NEW SCRUB SINK. PIPE $\frac{1}{2}$ " CW AND $\frac{1}{2}$ " HW DOWN IN WALL CAVITY TO SINK. PROVIDE THERMOSTATIC MIXING VALVE. REFER TO PIPING DETAIL B

13. NEW SHOWER. PIPE $\frac{1}{2}$ CW AND $\frac{1}{2}$ HW DOWN IN WALL CAVITY TO SHOWER. PROVIDE THERMOSTATIC MIXING VALVE. REFER TO PIPING DETAIL C

GENERAL NOTES 1. ALL PIPE SIZES ARE IN INCHES UNLESS OTHERWISE NOTED

10/20/17 JLM JOB NUMBER CHECKED BY 11241 лм WDC# 17-52