



POOL FOUNDATION PLAN - MECHANICAL  
SCALE: 1/8" = 1'-0"

LOWER FLOOR PLAN  
SCALE: 1/8" = 1'-0"


MAIN FLOOR PLAN  
SCALE: 1/8" = 1'-0"

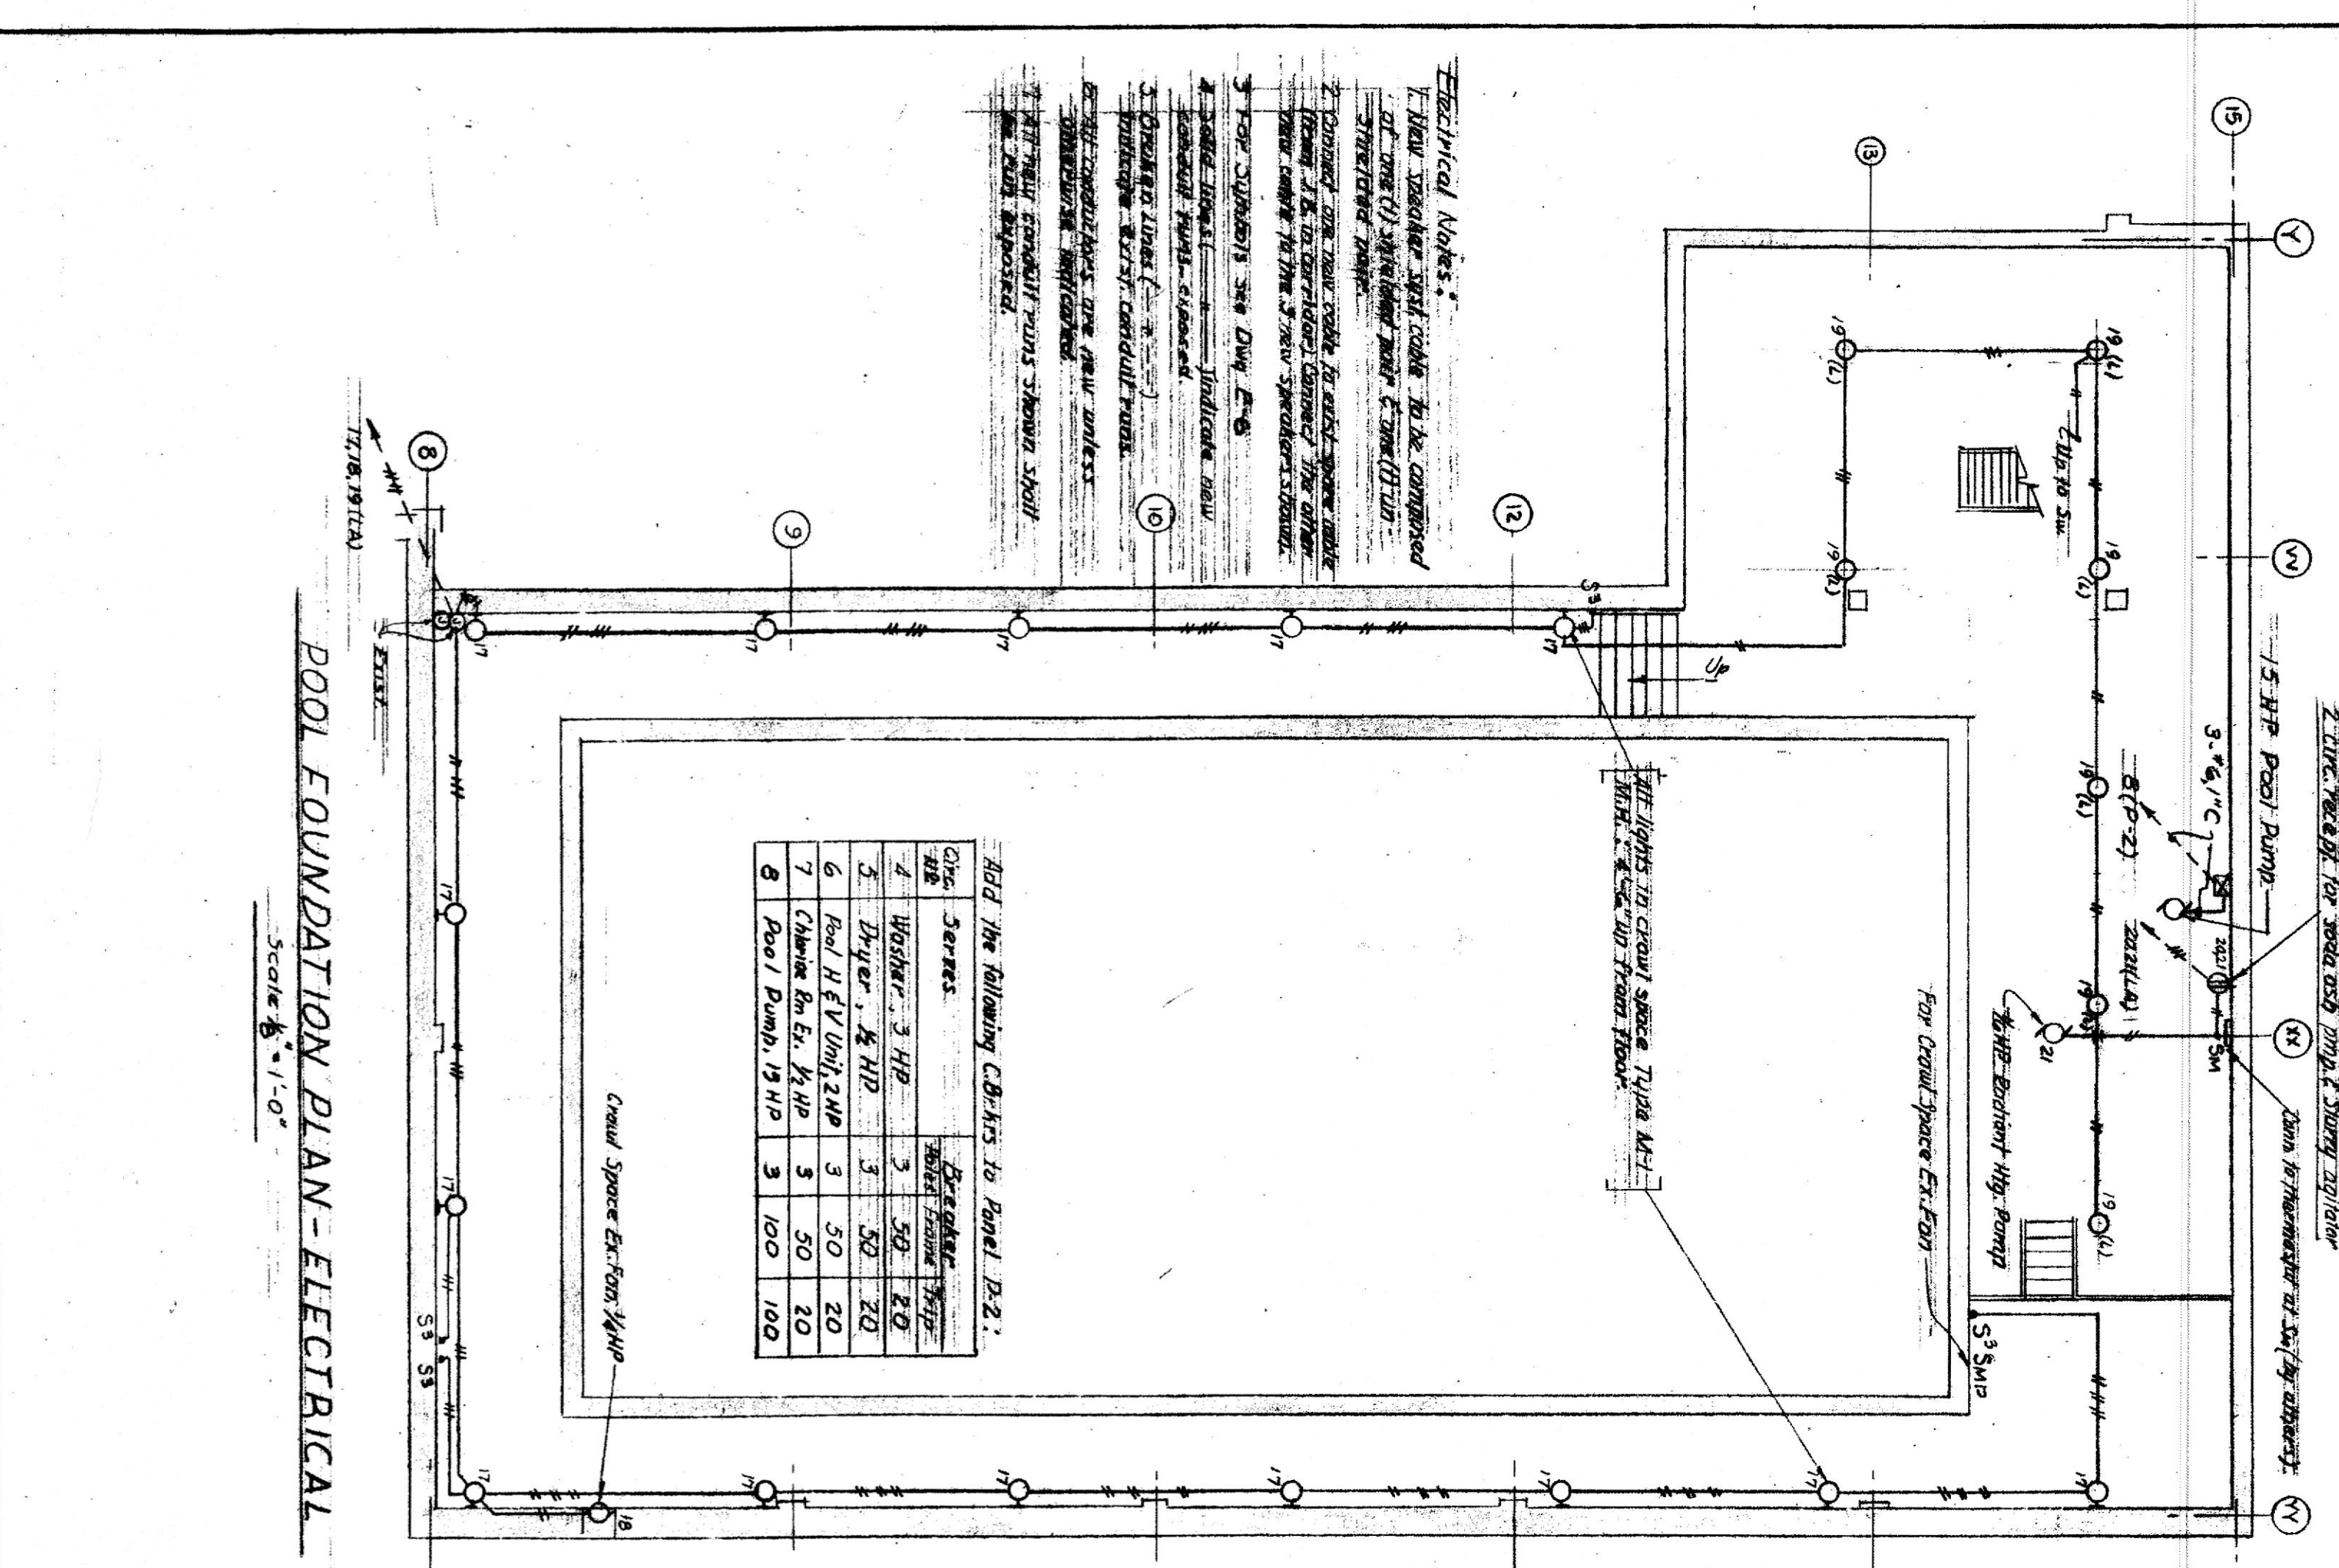

POOL FOUNDATION PLAN - ELECTRICAL  
SCALE: 1/8" = 1'-0"

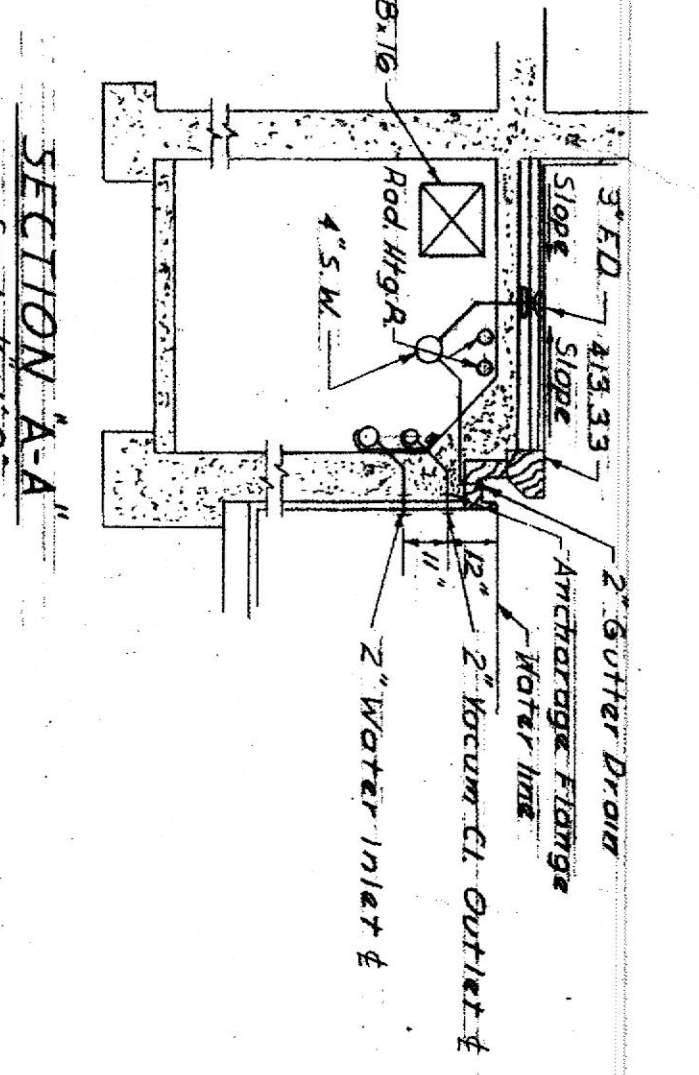

SECTION A-A  
SCALE: 1/8" = 1'-0"

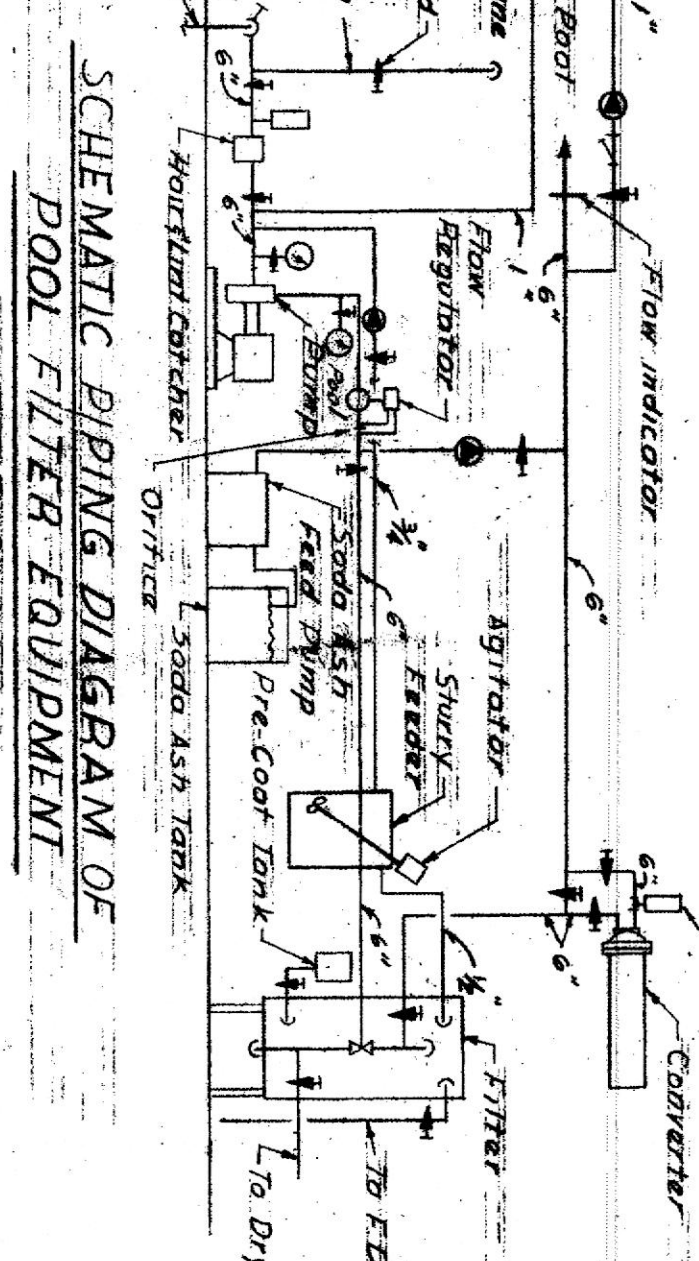


SCHEMATIC PIPING DIAGRAM OF POOL FILTER EQUIPMENT  
SCALE: 1/8" = 1'-0"

SCHEDULE OF RADIANT COILS


COIL NO.	LENGTH	WIDTH	AREA	NO. OF TUBES
1	105'-0"	11'-0"	1153	11
2	46'-0"	5'-0"	230	2
3	33'-0"	2'-0"	66	2
4	22'-0"	4'-0"	88	2
5	38'-0"	5'-0"	190	3

Radiant Heating Coils 1/2" O.D.


DETAIL OF COIL DIMENSIONS  
SCALE: 1/8" = 1'-0"

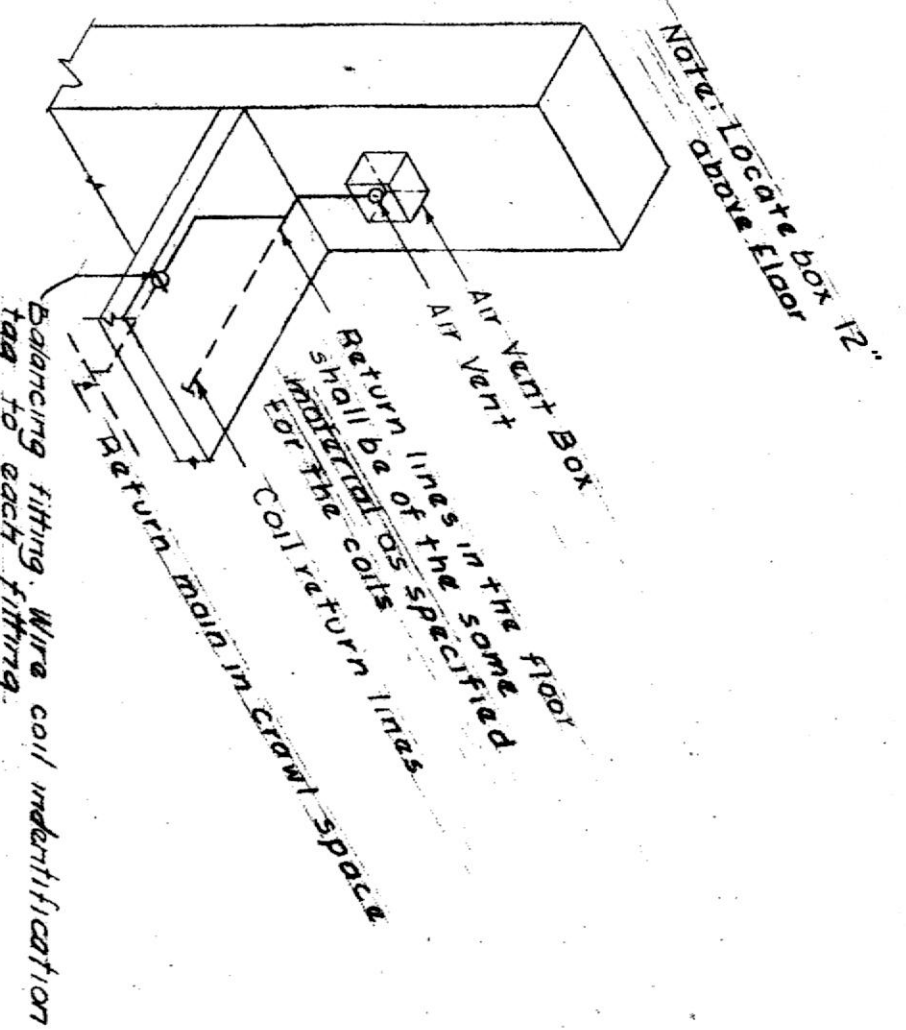

DETAIL OF AIR VENT BOX IN WALL  
SCALE: 1/8" = 1'-0"

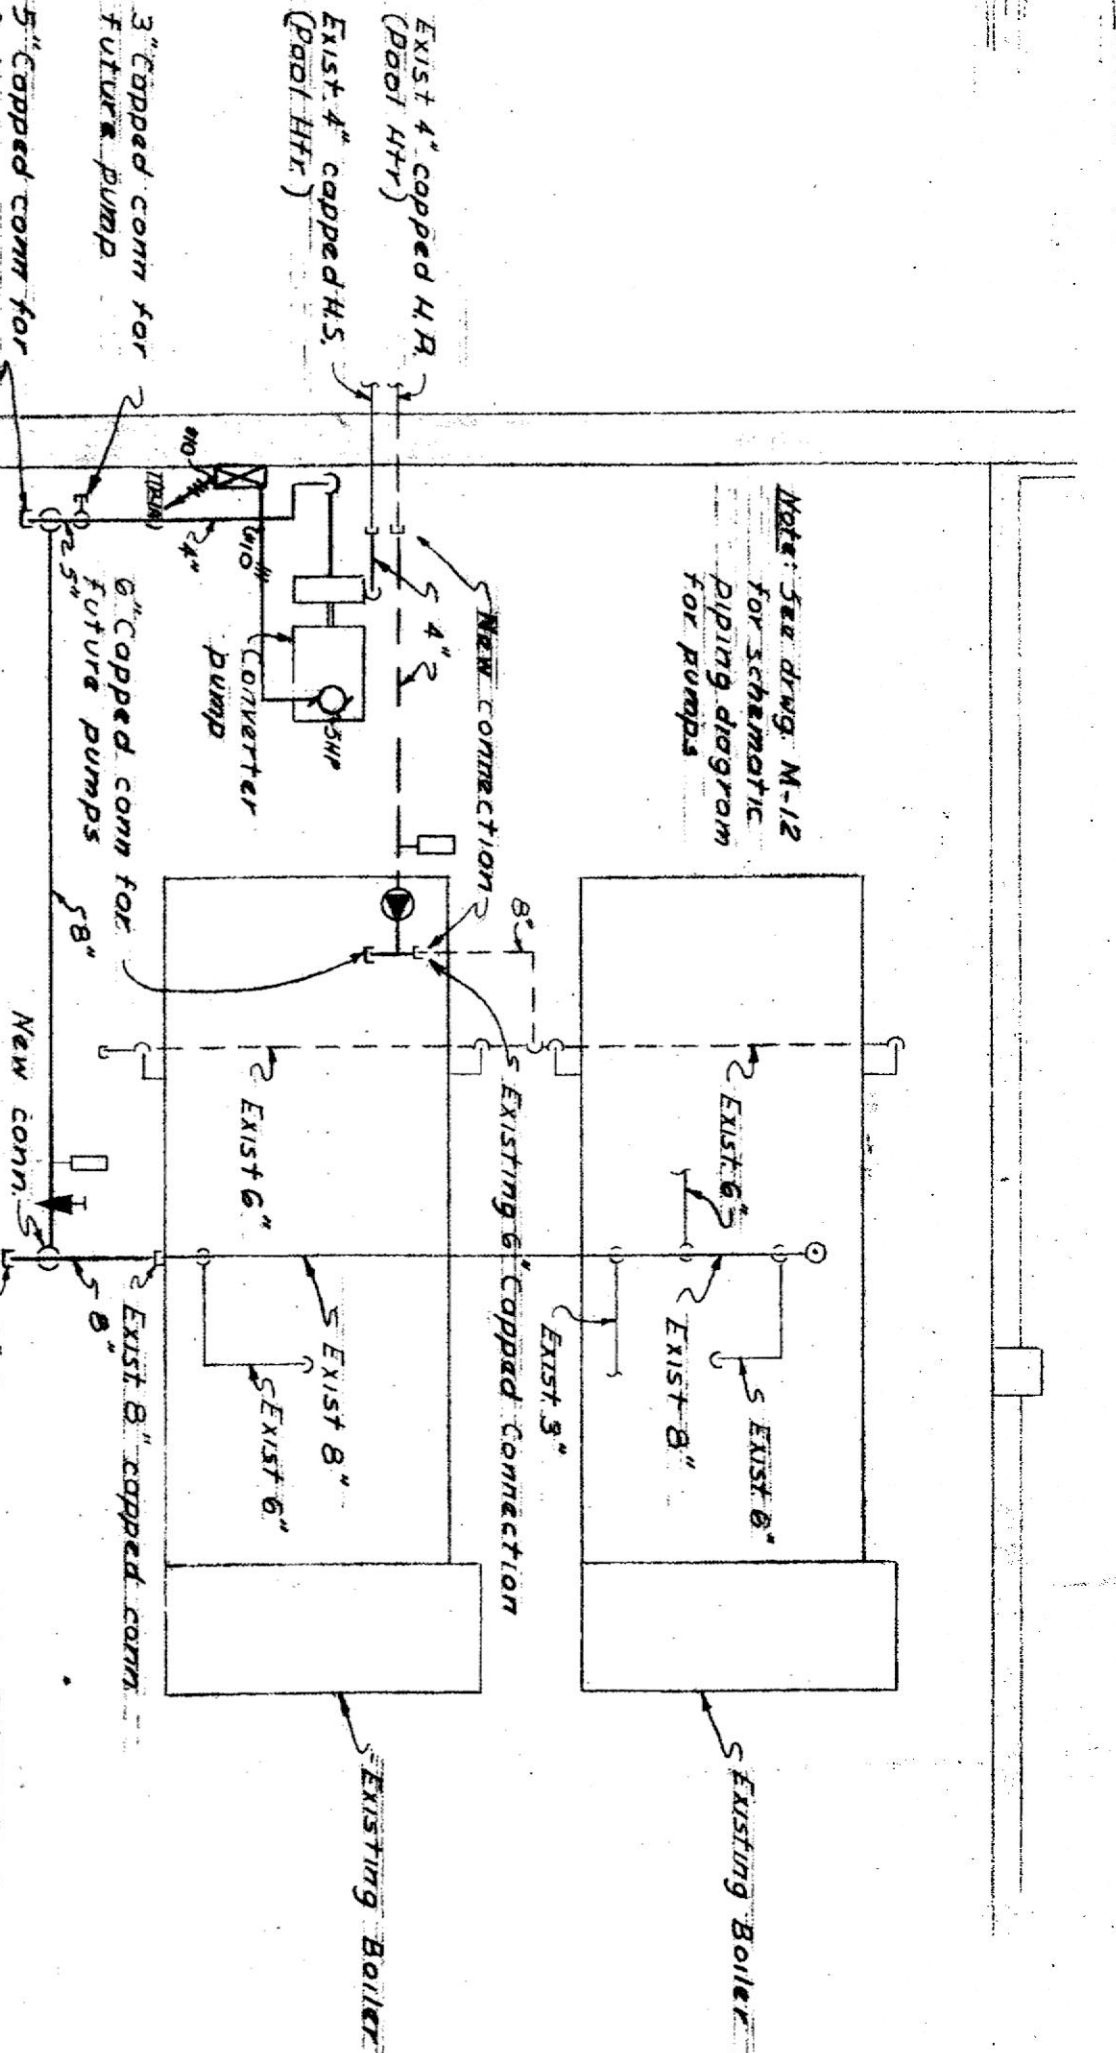

LAYOUT OF EXISTING BOILER ROOM  
SCALE: 1/8" = 1'-0"

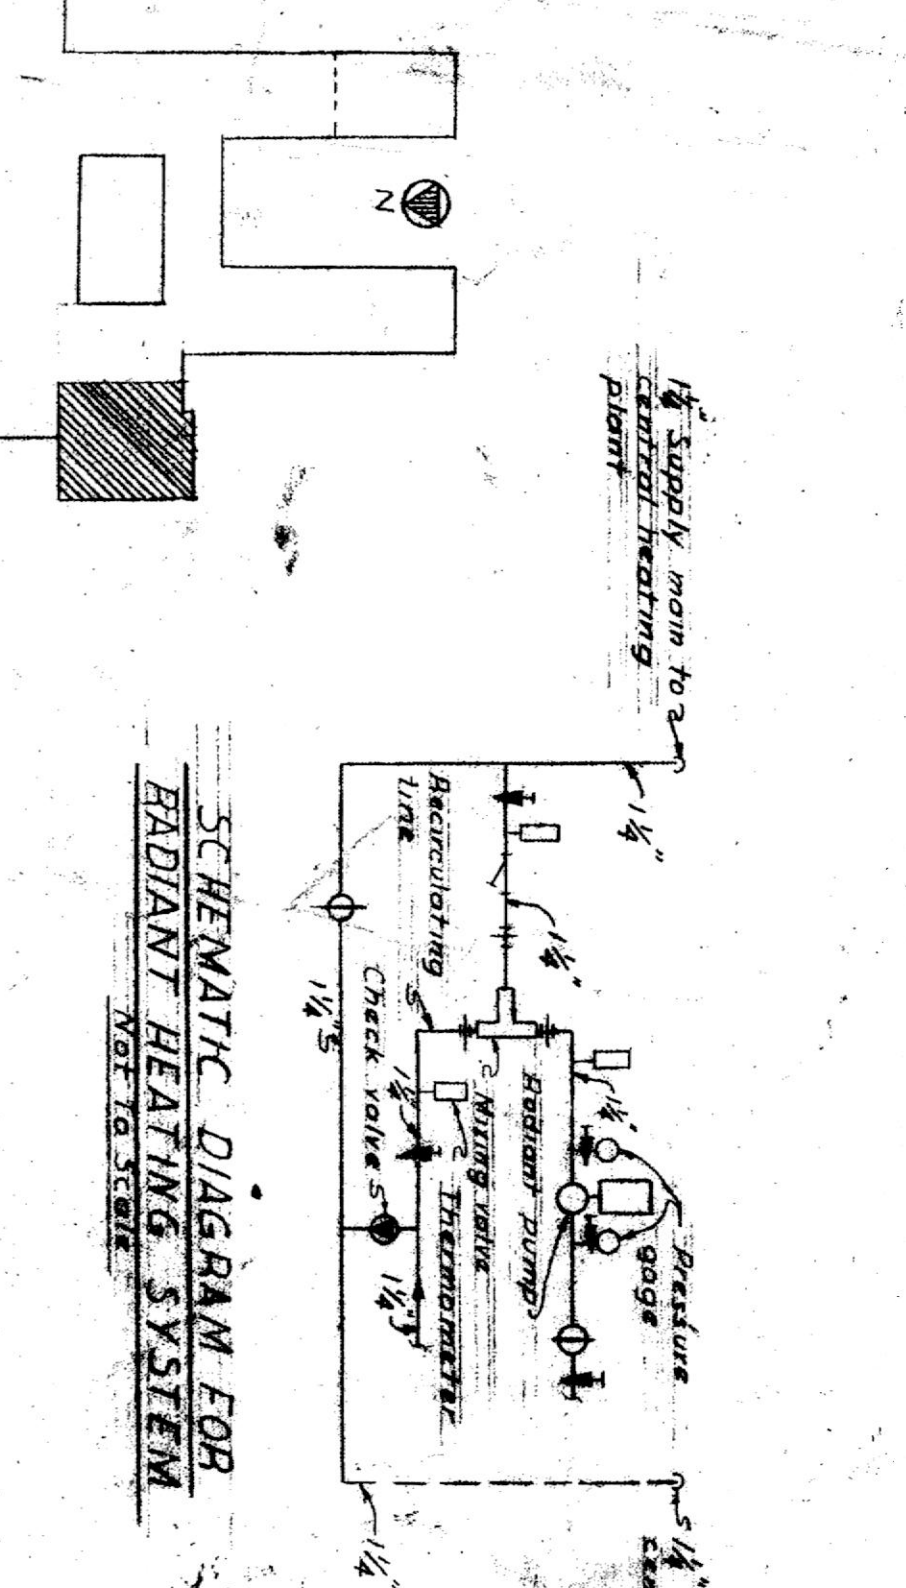

SCHEMATIC DIAGRAM FOR RADIANT HEATING SYSTEM  
SCALE: 1/8" = 1'-0"

ALTERNATE NO. 9 (ADDENDUM NO. 3)  
COMPLETE INTERNAL FINISH OF POOL  
NOTRE DAME PREPARATORY SCHOOL  
BALTIMORE COUNTY, MARYLAND  
UPPER SCHOOL  
FOR THE  
SCHOOL SISTERS OF NOTRE DAME

TAYLOR AND FISHER ARCHITECTS  
130 W. HAMILTON ST., BALTIMORE, I. MD.  
VAN RUSSELL & SWEET - STRUCTURAL ENGINEERS  
HENRY ADAMS, INC. - MECHANICAL ENGINEERS  
MARTIN HORNELL - LANDSCAPE ARCHITECT

JOB NO. 1118  
DATE: APRIL 7, 1958  
DRAWING NUMBER  
ME 101