



AREA MAP

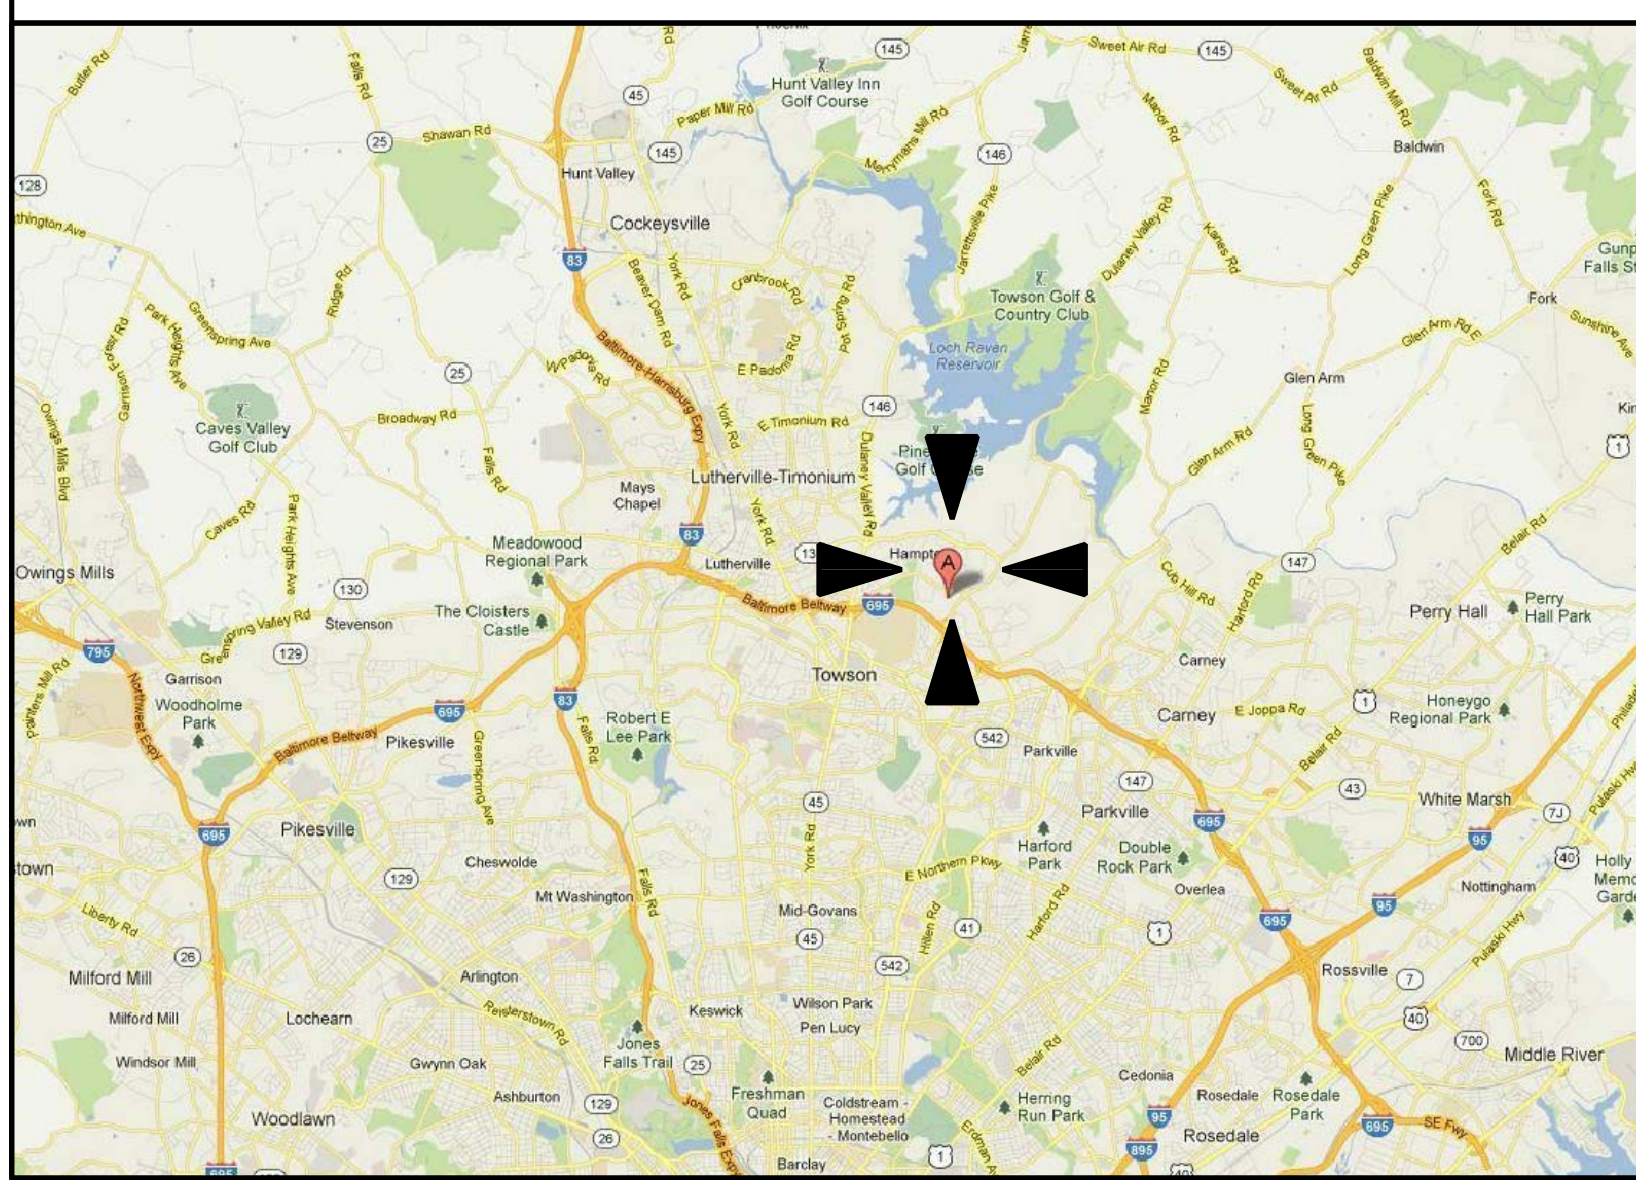

LOCATION MAP

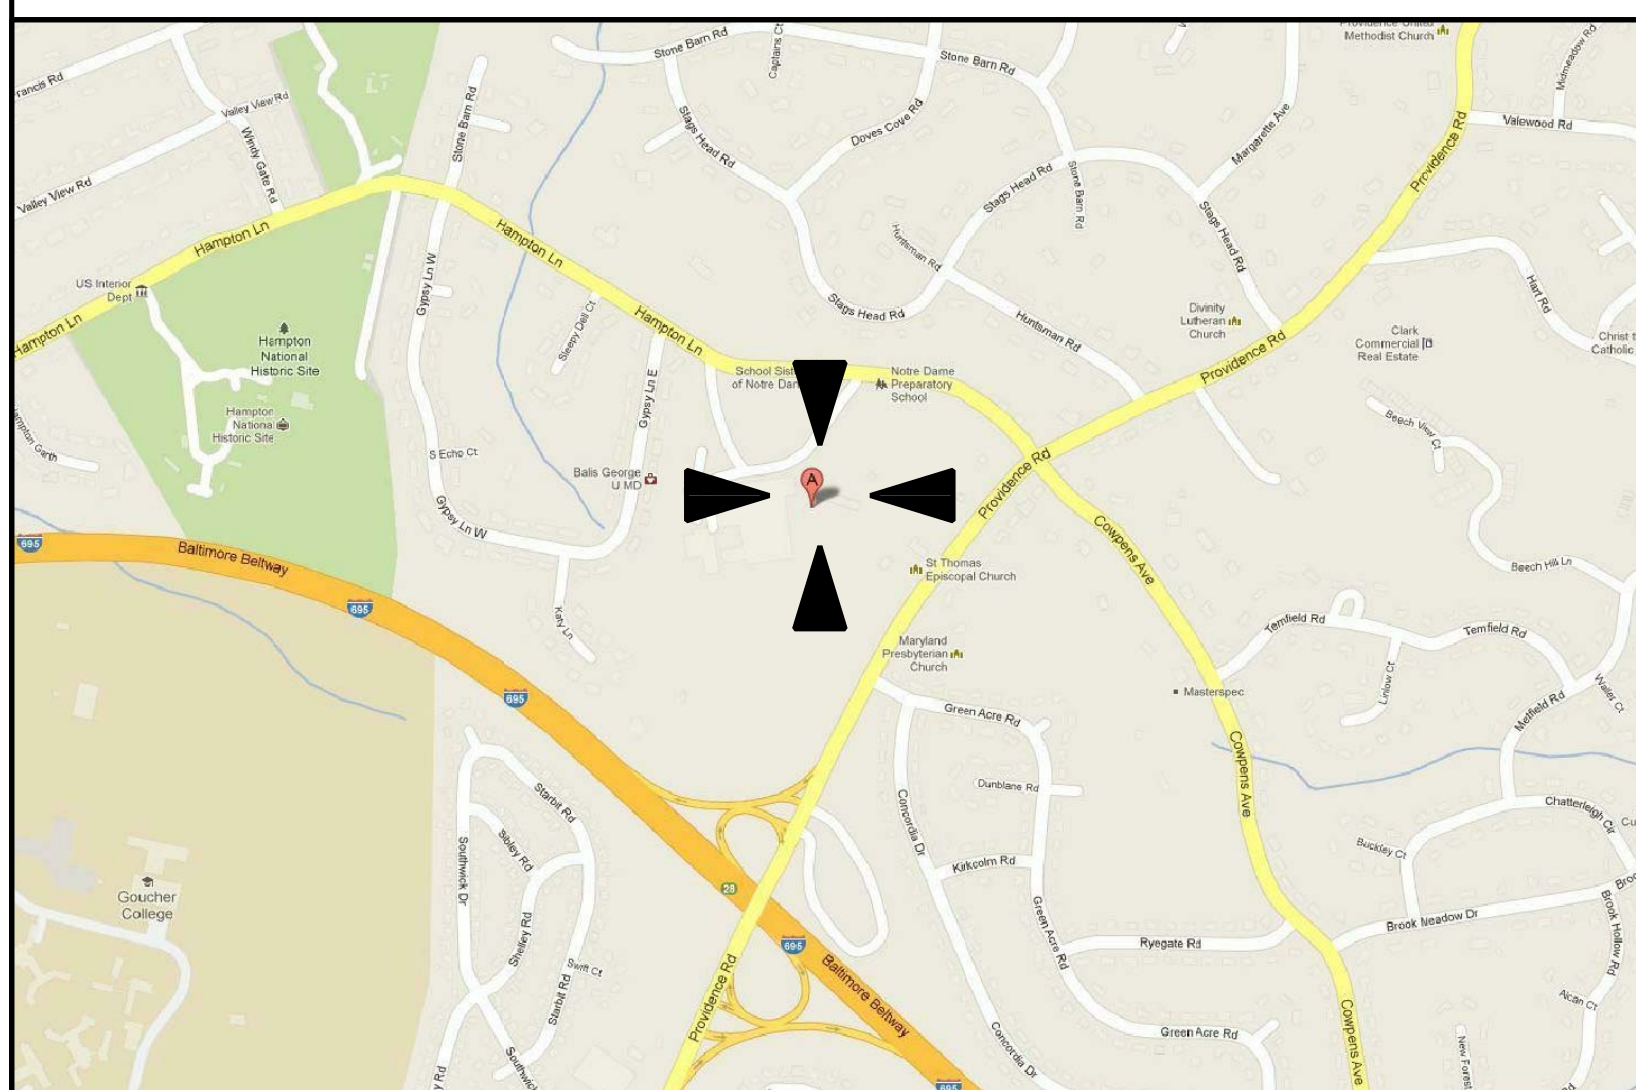

Notre Dame Preparatory School

815 Hampton Lane,
Towson, MD 21286

Convent Renovations PERMIT & CONSTRUCTION 06-17-2013

Owner / Developer
Notre Dame Preparatory School
815 Hampton Lane,
Towson, MD 21286
Office: 410-825-6202

Architect / Lab Planner
Gaudreau, Inc.
810 Light Street
Baltimore, MD 21230
PHONE (410) 837-5040 FAX (410) 837-8093

Construction Manager
Constantine Commercial Construction, Inc.
9494 Deereco Rd
Lutherville, MD 21093
Office: 410- 453-0150

Mechanical / Electric / Plumbing
JennErik Engineering, Inc.
4322 Cross Brook Drive
Perry Hall, MD 21128-9854
Office: 410-404-4713

ARCHITECTURAL SYMBOLS AND MATERIALS

ARCHITECTURAL ABBREVIATIONS

A A/C AIR CONDITIONING ACC ACCESSIBLE ACQ/CS ACQUISITION ADMIN ADMINISTRATION APC ACQUISITION PANEL C/LG ADJ ADJUTANT AFF ABOVE FINISHED FLOOR AGGR AGGREGATE AHU AIR HANDLING UNIT ALM ALUMINUM ANCO ANODIZED APPROX APPROXIMATELY ASST ASSISTANT AVG AVERAGE	B BB BULLETIN BOARD BC BOOKCASE BD BOARD BTM BOTTOM BLDG BUILDING BLKHD BLOCKHEAD BOT BOTTOM BSMT BASEMENT BTM BETWEEN BUR BUILT-UP ROOFING	C CAB CABINET CD CONSTRUCTION DOCUMENTS CER CERAMIC CFMF GOLD FORMED METAL FRAMING CG CORNER GUARD CJ CONTROL JOINT CL6 CL6 CLD CLOSET CLR CLEAR CMU CONCRETE MASONRY UNIT CO GASED OPENING COL COLUMN CONC CONCRETE CONF CONFERENCE CONSTR CONSTRUCTION CONT CONTINUOUS COORD COORDINATE CORR CORROSION CPT CAST STONE CS CASIUM CT CERAMIC TILE CTR CENTER CK CHECK	D DBL DEEP DEG DEGREE DEPT DEPARTMENT DET DETAIL DF DRINKING FOUNTAIN DIA DIAMETER DIFF DIFFERENCE DIM DIMENSION DIV DIVISION DWM DISTANCE DOC DESIGNED WATER DS DAMPROOFING DS DOCUMENT DRI DRAIN DNW DOWNFLOW DRAIN DRAINING	E EA EAST EACH EACH EIP/PS EXTERIOR INSULATION + FINISH SYSTEM EJ EXPANSION JOINT EL ELEVATION ELEC ELECTRIC ELEV ELEVATOR EMER EMERGENCY ENCL ENCLOSURE EP ELECTRICAL PANEL EQ EQUAL EQUIP EQUIPMENT EXIST EXISTING EXT EXTERIOR EXTINGUISHER EWC ELECTRIC WATER COOLER EWS EYE WASH STATION	F FC FILE CABINET FC BRK FACE BRICK FDX FLOOR DRAIN FDN FOUNDATION FE FIRE EXTINGUISHER FEC FIRE EXTINGUISHER CAB FFFE FURNITURE FIXTURE & EQUIPMENT FHC FIRE HOSE CABINET FIC FIRE-RETARDANT-TREATED FIN FINISH FIN FLR FINISH FLOOR FLG FLOORING FLASH FLASHING FLX FLEXIBLE FLR FLOOR FLUOR FLUORESCENT FOM FACE OF WALL FP FIRE PROTECTION FRMS FRAMING FRZ FREEZER FT FEET OR FOOT FTG FOOTING FURN FURNITURE	G G6 GAGE GALV GALVANIZED GEN GENERAL GL GLASS GFRB GYPSUM BOARD GFRFC GLASS FIBER REINFORCED CONCRETE	H H HIGH H&C/H HOT AND COLD WATER HAZ MAT HAZARDOUS MATERIALS HBB HOSE BIBB HC HOLLOW CORE HDW HARDWARE HM HOLLOW METAL HORIZ HORIZONTAL HK/PS HOUSEKEEPING HT HEIGHT HVAC HEATING, VENTILATING AND A/C HW HOT WATER HWY HIGHWAY	I ID INSIDE DIAMETER, IDENTIFICATION INCL INCLUDED INFO INFORMATION INSUL INSULATION INT INTERIOR	J JAN JANITOR	K KIT KITCHEN KO KNOCKOUT KPL KICK PLATE	L LAB LABORATORY LAM LAMINATE LAV LAVATORY LB LB LF LINEAR FEET (FOOT) LH LEFT-HAND LIB LIBRARY LIN LINEAR LL LOWER LEVEL LOC LOCATION LPT LOW POINT LT LIGHT LT GA LIGHT GAGE LT HT LIGHT HEIGHT LVR LOWER LWC LIGHTWEIGHT CONCRETE	M MAGH MACHINE MAINT MAINTENANCE MATT MATERIAL MAX MAXIMUM MECH MECHANICAL MEMB MEMBRANE METAL METAL MEZZ MEZZANINE MFG MANUFACTURING MFR MANUFACTURER MNT MOUNTED MNTD MOUNTED MISG MISCELLANEOUS MO MASONRY OPENING MTD MOUNTED MEET MEETING	N N NORTH NA NOT APPLICABLE NATL NATIONAL NG NATURAL GAS NIC NOT IN CONTRACT NO NUMBER NOM NOMINAL NTS NOT TO SCALE	O O OXYGEN OA OVERALL OC ON CENTER OD OUTSIDE DIAMETER OPD OVERFLOW DRAIN OFF OFFICE OH OR OVERHEAD DOOR OPH OPPOSITE HAND OPNG OPENING OPT OPPOSITE OPTION OPTIONAL ORD OVERFLOW ROOF DRAIN ORIG ORIGINAL OZ OUNCE	P PAR PARALLEL PART PARTIAL PAT PATTERN PBRP PERPENDICULAR PH PENTHOUSE PKG PACKAGE PL PROPERTY LINE PLAS PLASTER LAMINATE PLYND PLYWOOD PNL PANEL PR PAIR PRELIM PRELIMINARY PREP PREPARATION PREV PREVIOUS PROJ PROJECT PSI POUNDS PER SQ IN PTN PARTITION	Q QT QUARRY TILE QUARTER QUARTER QTY QUANTITY QUAD QUADRANT	R R RISER, RADIUS R/RD RESEARCH & DEVELOPMENT RCP REFLECTED CEILING PLAN RD ROOF DRAIN ROAD REBAR REINFORCING STEEL BARS REF REFRIGERATOR, REFERENCE REIN REINFORCE RESIL RESILIENT REST RESTROOM REQD REQUIRED REV REVISION RH RIGHT HAND RM ROOM RO ROOF OPENING RCPN RIGHT OF WAY RTU ROOF TOP UNIT RNL RAIN WATER LEADER	S S SOUTH SC SOLID CORE SCHED SCHEDULE SCHEM SCHEMATIC SD STOREY DRAIN SECT SECTION SHT SHEET SM SIMILAR SK SKETCH SPEC SPECIFICATION SQ SQUARE SQ FT SQUARE FEET SQ IN SQUARE INCH SST STAINLESS STEEL ST STREET STA STATION STD STANDARD STOR STORAGE STRUC STRUCTURAL SUSP SUSPENDED SYM SYMBOL SYMM SYMMETRICAL	T T TREAD TOP 4 BOTTOM T&G TONGUE & GROOVE TECH TECHNICAL TEL TELEPHONE TEMP TEMPORARY TKR TERRAZZO THK THICKNESS THRES THRESHOLD THRU THROUGH TKBD TACKBOARD TO TOP OF TOC TOP OF CONC TOM TOP OF MASONRY TOPO TOPOGRAPHY TOS TOP OF STEEL TOP OF SLAB TOW TOP OF WALL TS TUBE STEEL TV TELEVISION TYP TYPICAL	U UN UNFINISHED UNIN UNLESS OTHERWISE NOTED UTIL UTILITY	V VAC VACUUM VAR VARIES VB VINYL BASE VCT VINYL COMPOSITION TILE VERT VERTICAL VEST VESTIBULE VIF VERIFY IN FIELD VWC VINYL WALL COVERING	W W WITH WO WITHOUT W/O WITHOUT WBL WOOD BLOCKING WC WATER CLOSET WD WOOD WDR WINDOW WH KEEP HOLE WHSE WAREHOUSE WATERPROOFING WORKING POINT WPT WEIGHT WTR WATER	X XFRM TRANSFORMER	Y YD YARD
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DRAWING LIST

SHEET #	SHEET NAME	06/17/13 PERMIT	06/17/13 CD
ARCHITECTURALS			
G-001	COVER SHEET	•	•
G-002	CODE ANALYSIS & FIRE PROTECTION PLANS	•	•
D-101	DEMOLITION PLAN	•	•
A-102	SECOND & THIRD FLOOR PLANS	•	•
A-112	SECOND & THIRD FLOOR REFLECTED CEILING PLANS	•	•
A-122	SECOND & THIRD FLOOR FINISHES PLANS	•	•
A-401	ENLARGED FLOOR PLANS & ELEVATIONS	•	•
A-402	ENLARGED FLOOR PLANS & ELEVATIONS	•	•
A-411	INTERIOR ELEVATIONS & DETAILS	•	•
A-601	SCHEDULES	•	•
PLUMBING			
P-001	GENERAL NOTES, ABBREVIATIONS, LEGEND & SCHEDULES	•	•
P-101	BASEMENT AND FIRST FLOOR PLAN - PLUMBING NEW WORK	•	•
P-102	SECOND AND THIRD FLOOR PLAN - PLUMBING NEW WORK	•	•
P-401	PART PLAN PLUMBING	•	•
P-601	RISER DIAGRAMS	•	•
MECHANICAL			
M-001	GENERAL NOTES, ABBREVIATIONS, LEGEND & SCHEDULES	•	•
M-101	SECOND AND THIRD FLOOR PLAN - HVAC NEW WORK	•	•
M-102	ROOF PLAN - HVAC NEW WORK	•	•
ELECTRICAL			
E-001	LEGEND, ABBREVIATIONS, NOTES & SCHEDULE	•	•
E-101	BASEMENT DEMOLITION & POWER PLANS	•	•
E-102	SECOND FLOOR LIGHTING & POWER PLANS	•	•
E-103	THIRD FLOOR LIGHTING & POWER PLANS	•	•
E-201	POWER RISER DIAGRAMS	•	•
E-301	SCHEDULES	•	•

REVISIONS		
NO	DATE	DESCRIPTION
	20 May 13	ELECTRICAL DRAWINGS
	17 June 13	PERMIT SUBMISSION
PROJECT NO: 13007-00		G-001
DATE: 06-13-13		

CODE ANALYSIS

PROJECT DESCRIPTION

THE BUILDING HAS THREE FULL FLOORS ABOVE GRADE WITH A BASEMENT. THE EXTERIOR WALLS OF THE BUILDING ARE CAVITY WALL CONSTRUCTION (BRICK & CMU) WITH NO THERMAL INSULATION. THE EXISTING WINDOWS ARE SINGLE PANE, WOOD FRAME. THE ROOF IS LOW-SLOPE BUILT-UP ROOF WITH LITTLE OR NO INSULATION WITH INTERNAL ROOF DRAINING AND NO PARAPETS. ALL FLOORS AND THE ROOF STRUCTURE ARE CONSTRUCTED OF CONCRETE PLANKS WITH CONCRETE TOPPING SUPPORTED BY CMU BEARING WALLS AND A FEW CONCRETE COLUMNS.

APPLICABLE CODES

- INTERNATIONAL EXISTING BUILDING CODE (IEBC) / 2012
- INTERNATIONAL MECHANICAL CODE / 2012
- NATIONAL ELECTRIC CODE / 2011
- NATIONAL STANDARD PLUMBING CODE / 2009
- INTERNATIONAL ENERGY CODE / 2012
- NFPA 1 - FIRE PREVENTION CODE / 2004
- NFPA 13 - INSTALLATION OF SPRINKLER SYSTEMS
- NFPA 72-94 NATIONAL FIRE ALARM CODE
- NFPA 101 - LIFE SAFETY CODE / 2009
- COMAR 05.02.02 ADA/ADAAG MARYLAND ACCESSIBILITY CODE

3.1 BUILDING USE & TYPE OF CONSTRUCTION

OCCUPANCY TYPE: NON SEPARATED MIXED USE OCCUPANCIES

IBC 302: RESIDENTIAL (R), ASSEMBLY (A), STORAGE (S), BUSINESS (B)
 NFPA 101 6.1.8: RESIDENTIAL, 6.1.2: ASSEMBLY & 6.1.1: BUSINESS
 NFPA 13 & 13-R.

SPACE	OCCUPANCY	CLASSIFICATION
3RD FLOOR	CONVENT/ASSEMBLY	R-2 (A)
2ND FLOOR	CONVENT/ASSEMBLY	R-2 (A)
1ST FLOOR	OFFICE	B
BASEMENT	STORAGE/ MECH	S

(ACCESSORY USE)

IBC 302: RESIDENTIAL (R), ASSEMBLY (A), STORAGE (S), BUSINESS (B)

303.1.2 SMALL ASSEMBLY SPACES:
 THE FOLLOWING ROOMS AND SPACES SHALL NOT BE CLASSIFIED AS ASSEMBLY OCCUPANCIES:
 2. A ROOM OR SPACE USED FOR ASSEMBLY PURPOSES THAT IS LESS THAN 750 SF IN AREA AND ACCESSORY TO ANOTHER OCCUPANCY SHALL BE CLASSIFIED AS A GROUP B OCCUPANCY OR AS PART OF THAT OCCUPANCY.

TYPE OF CONSTRUCTION:

IBC TABLE 601 - TYPE IIB, NON-COMBUSTIBLE MATERIALS

3.2 SPECIAL OCCUPANCY REQUIREMENT- INCIDENTAL USE AREAS (IBC 2012 TABLE 509)

SPACE	SEPARATION/PROTECTION
FURNACE ROOM (OVER 400,000 BTU EQUIPMENT)	1 HR OR AUTOMATIC SPRINKLERS
BOILER ROOM (OVER 15 PSI AND 10 HORSE POWER EQUIPMENT)	1 HR OR AUTOMATIC SPRINKLERS
LAUNDRY ROOM (OVER 100 SF)	1 HR OR AUTOMATIC SPRINKLERS
STORAGE (OVER 100 SF)	1 HR OR AUTOMATIC SPRINKLERS
WASTE AND LINEN COLLECTION (OVER 100 SF)	1 HR OR AUTOMATIC SPRINKLERS

3.3 EXTERIOR WALL FIRE RATING DUE TO DISTANCE

EQUAL TO OR GREATER THAN 30 FT.: 0 HR.

3.4 OCCUPANCY CALCULATIONS :

PER IBC 2012 (TABLE 1004.1.2):

FLOOR	OCCUPANCY	SF/OCCUPANT	TOTAL
3rd FLOOR:			
635 SF / 425 SF	ASSEMBLY	15 NET	42
3871 SF	RESIDENTIAL (R-2)	200 GROSS	19
200 SF	STORAGE	300 GROSS	1
TOTAL			62
2nd FLOOR:			
690 SF	ASSEMBLY	7 NET	98
3871 SF	RESIDENTIAL (R-2)	200 GROSS	19
200 SF	STORAGE	300 GROSS	1
TOTAL			118
1st FLOOR:			
6635 SF	BUSINESS	100 GROSS	66
TOTAL			66
BASEMENT:			
1564 SF	STORAGE/ MECHANICAL	300 GROSS	5
TOTAL			5
TOTAL BUILDING OCCUPANCY			251

5.1 ALLOWABLE HEIGHT & AREA

CONVENT	ACTUAL AREA (SF)	ALLOWABLE AREA (SF) PER IBC 506
	6635 SF	16,000 SF

PER IBC TABLE 503 FOR TYPE IIB CONSTRUCTION USE GROUP R-2:

- ALLOWABLE TABULATED AREA AND HEIGHT, 16,000 SQ.FT. AND 4 STORIES
- AUTOMATIC SPRINKLER SYSTEM INCREASE (IBC SECTION 506.3) 200 %
- FRONTAGE INCREASE (IBC SECTION 506.3) 200 %

ACTUAL FIRST FLOOR AREA: 6635 SQ.FT.

CALCULATION
 AUTOMATIC SPRINKLER SYSTEM INCREASE: 200% X 16,000 = 32,000 SF
 FRONTAGE INCREASE: 200% X 16,000 = 32,000 SF
 AREA ALLOWED/FLOOR: 16,000 SF X 3 STORIES = 48,000 SF
 TOTAL AREA ALLOWED: 48,000 SF X 3 STORIES = 144,000 SF

ALLOWABLE HEIGHT: 5 STORIES
 ACTUAL HEIGHT: 3 STORIES PLUS BASEMENT

6.1 CONSTRUCTION CLASSIFICATION

BUILDING FIRE RATINGS:

IBC-2012 (TABLE - 601) NFPA - 2009 (TABLE A.8.2.1.2)	IBC 2012 TYPE IIB	NFPA 2009 TYPE II
STRUCTURAL FRAME	0	
EXTERIOR BEARING WALL	0	
EXTERIOR NONBEARING WALL	0	
INTERIOR BEARING WALL	0	
INTERIOR NONBEARING WALL	0	
FLOOR CONSTRUCTION	0	
ROOF CONSTRUCTION	0	

6.2 COMBUSTIBLE MATERIAL IN TYPE II CONSTRUCTION

- (IBC SECTION 603)
 FIRE-RETARDANT-TREATED WOOD SHALL BE ALLOWED IN:
- NONBEARING PARTITIONS (LESS THAN 2 HR WALL)
 - NONBEARING EXTERIOR WALLS WITH NO FIRE RATING
 - ROOF CONSTRUCTION
 - THERMAL & ACOUSTIC INSULATION WITH A FLAME SPREAD LESS THAN 25
 - FOAM PLASTIC (SEE IBC SECTION 26)
 - ROOF COVERINGS OF A, B, & C CLASSIFICATIONS
 - INTERIOR WOOD FLOORS, PANELING, TRIM, DOORS, ETC. PLATFORMS PER IBC 410
 - BLOCKING FOR HANDRAILS, CABINETS, WINDOW & DOOR FRAMES
 - MASTICS AND SEALANTS
 - NAILING AND FIRING STRIPS

7.1 FIRE-RESISTANCE RATING REQUIREMENTS

BUILDING FIRE RATINGS:

IBC-2012 (TABLE 716.5) NFPA - 2009 (TABLE A.8.2.1.2)	IBC 2012 TYPE IIB	NFPA 2009 TYPE II
FIRE WALLS - USE GROUP R-2, B .PROTECTIVE OPENING RATING (706.3.9 & 715.4) (OTHER FIRE BARRIERS: 3/4 HR.)	2 1 1/2	
FIRE ENCLOSURE OF EXITS (1020.1) .PROTECTIVE OPENING RATING	1 1	
*EXTERIOR WALL IN AN EXIT: NO RATING TABLES 601 & 602		
SHAFTS AND ELEVATOR HOIST WAYS .PROTECTIVE OPENING RATING (101.4 / 8.6.5)	1 < 4 STORIES 1	
SMOKE BARRIER EXIT ENCLOSURE, IBC 1019.1: 1 HR. ENCLOSURE	0	
CORRIDOR WALLS, IBC 708.1.4 & TABLE 1018.1	R: 0.5	

*GLAZING IN EXIT ENCLOSURE DOORS, IBC 715.3.4.1: 100 SQ. IN. AREA

*FIRE DOORS CLOSING, IBC 715.4.7:
 DOORS SHALL BE SELF-CLOSING
 DOORS SHALL BE SECURED W/ LATCH WHEN CLOSED

7.2 DWELLING AND SLEEPING UNIT SEPARATION IN TYPE IIB :

- IBC 708.3:
 • NOT LESS THAN 1/2 HR IN BUILDING EQUIPPED WITH AUTOMATIC SPRINKLER SYSTEM

7.3 DUCTS & AIR TRANSFER OPENINGS:

FIRE BARRIER DAMPERS, IBC 716.5.2:

7.4 REFUSE AND LAUNDRY CHUTES

- IBC 707.3.1:
 • SHAFT WALL-1 HR RATED (707.4)
 • REFUSE AND LAUNDRY CHUTE ACCESS ROOM: 1HR RATED (707.3.3)
 • DOOR: .75 HR & SMOKE ACTIVATED DOOR (715.4.7.3)

7.5 ELEVATOR AND DUMBWAITER

- IBC 707.4:
 • SHAFT WALL-1HR RATED (707.4)

8.1 INTERIOR FINISH REQUIREMENTS: WALL & CEILING

IBC-2012 (TABLE - 803.9 NFPA - 2009 (TABLE A.10.2.2)	CLASS		
	R-2	B	A-3
VERTICAL EXITS & PASSAGEWAYS:	C	B	B
CORRIDORS:	C	C	B
ROOMS & ENCLOSED SPACES:	C	C	C

8.2 INTERIOR FINISH REQUIREMENTS: FLOOR (IBC 804.1)

CLASSIFICATION, IBC 804.4.1 EXCEPTION: FINISH MUST COMPLY WITH DOC FF-1 "FILL TEST"

9.1. FIRE PROTECTION SYSTEM REQUIREMENTS:

- PROTECTION SYSTEMS SHALL BE INSTALLED, REPAIRED, OPERATED AND MAINTAINED IN ACCORDANCE WITH IBC 2012
- SUPERVISORY SERVICE, IBC 901.6.1: AUTO. SPRINKLER SYSTEMS SHALL BE MONITORED BY AN APPROVED SUPERVISING STATION.
- SPRINKLER SYSTEM SHALL BE DESIGNED AND INSTALLED IN ACCORDANCE WITH NFPA 13

	REQUIRED	IBC 2012	NFPA 2009	PROVIDED
AUTOMATIC SPRINKLERS:	YES	903.3.1.1	9.7.1.1	YES
ALT. AUTOMATIC FIRE SPRINKLER:	NO**	904.2	9.7.3.1	NO
STANDPIPE SYSTEM:	NO**	905.1	9.7.4.2	NO
PORTABLE FIRE EXTINGUISHERS:	YES	906.1	9.7.4.1	YES
FIRE ALARM SYSTEM:	YES	907.2	9.6.7.1	YES
SMOKE CONTROL SYSTEM:	NO	909.1	9.3.1	NO

*WHERE REQUIRED PER 904.2.1: COMMERCIAL HOOD AND DUCT SYSTEMS

** STANDPIPES, IBC 905.1: NOT REQUIRED DUE TO BUILDING HT. PORTABLE FIRE EXTINGUISHERS, IBC 906.1: LOCATE & INSTALL PER NFPA 10 FIRE ALARM & DETECTION SYSTEM, IBC 907.1 WHERE REQUIRED, IBC 907.2.2: GROUP B - NOT REQUIRED DUE TO OCCUPANCY LOAD (OCCUPANTS ON 2ND FLOOR @ 1 OCC. PER 100 SF)

10.1 MAXIMUM TRAVEL DISTANCE TO EXIT:

	USE GROUP R-2
IBC-2012 (TABLE - 1016.2 WITH SPRINKLER	250'
NFPA - 2009 (TABLE A.1.6) WITH SPRINKLER	325'/200'
PROVIDED WITH SPRINKLER	63' MAX

10.2 COMMON PATH OF EGRESS TRAVEL:

	B, A	R-2
IBC-2012 (1014.3) WITH SPRINKLER	100'/75'	125'
NFPA - 2009 (TABLE A.1.6) WITH SPRINKLER	NR/100'/75'	160'
ACTUAL MAXIMUM TRAVEL DISTANCE	60'	60'

10.3 MINIMUM CORRIDOR WIDTH REQUIREMENTS:

	REQD.	PROVIDED
IBC-2012 (1018.2)	44" MIN.	70"
NFPA - 2009 (38.2.3.2)	44" MIN.	70"

10.4 MAXIMUM DEAD END / DISTANCE:

USE GROUP:	REQUIRED	PROVIDED
IBC-2012 (1018.4) WITH SPRINKLER	50'	LESS THAN 20'
NFPA - 2009 (TABLE A.1.6) WITH SPRINKLER	50'	LESS THAN 20'

ALL DEAD END CORRIDORS ARE WITHIN THE 20' MAXIMUM DISTANCE.

10.5 EGRESS WIDTH PER OCCUPANT:

(IBC 1005.17 NFPA 101 GOVERNS):

	REQUIRED		PROVIDED	
	STAIRS	OTHER EGRESS	STAIRS	OTHER EGRESS
	0.3"	0.2"		
BASEMENT	1.5"	N/A	91"	N/A
FIRST FLOOR	19.8"	N/A	150"	56"
SECOND FLOOR	35.4"	N/A	150"	N/A
THIRD FLOOR	18.6"	N/A	100"	N/A

10.6 BOILER, INCINERATED AND FURNACE ROOMS (IBC 1015.3)

- * 2 EXITS REQUIRED IF >500 SF AND ANY FUEL FIRED EQUIP. EXCEEDS 400 K BTU; ONE PERMITTED TO BE A FIXED LADDER (N/A)

10.7 GUARDS & BALUSTRADES

- WHERE REQUIRED, IBC 1013.1:
 OPEN-SIDED STAIRS, RAMPS, LANDINGS AND FLOOR SURFACES LOCATED MORE THAN 30 IN. ABOVE THE GRADE OR FLOOR BELOW
- HEIGHT, IBC & NFPA 101: 30 IN. MIN. HEIGHT
- OPENING LIMITATIONS: UP TO 6" OPENING AS ALLOWED BY AHJ

10.8 PANIC HARDWARE

IBC 2006 1008.1.10
 GROUP A SPACE WITH OCCUPANCY LOAD >50


11.1 ACCESSIBLE TOILETS AND UNITS

SPACE	OCCUPANCY	CLASSIFICATION	ACCESSIBLE	TYPE A	TYPE B
3RD FLOOR	CONVENT	R-2	4% OF 8=1	1	NA
2ND FLOOR	CONVENT	R-2	4% OF 8=1	1	NA
1ST FLOOR	OFFICES	B	1	NA	NA
BASEMENT	STORAGE/ MECH	S	NA	NA	NA


12.1 SOUND TRANSMISSION

IBC 1201.2
 • WALLS, PARTITIONS AND FLOOR/CEILING ASSEMBLIES SEPARATING DWELLING UNITS FROM EACH OTHER OR FROM PUBLIC OR SERVICE AREAS SHALL HAVE A SOUND TRANSMISSION CLASS (STC) OF NOT LESS THAN 50 (45 IF FIELD TESTED) FOR AIR-BORNE NOISE WHEN TESTED IN ACCORDANCE WITH ASTM E 90.


FIRE PROTECTION PLANS

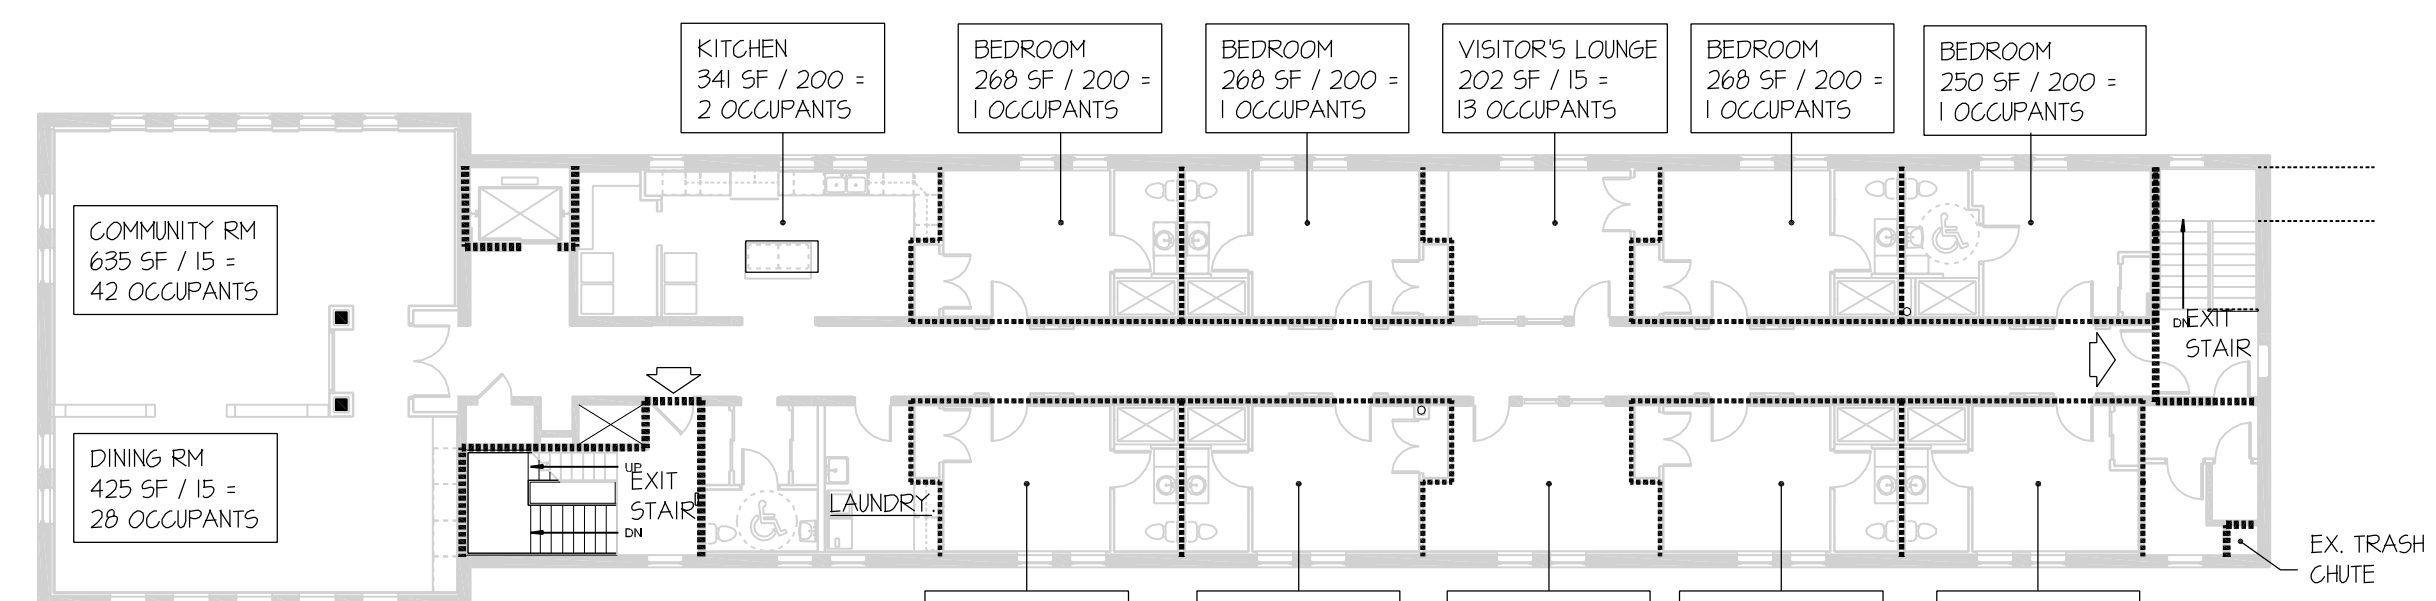


THIRD FLOOR

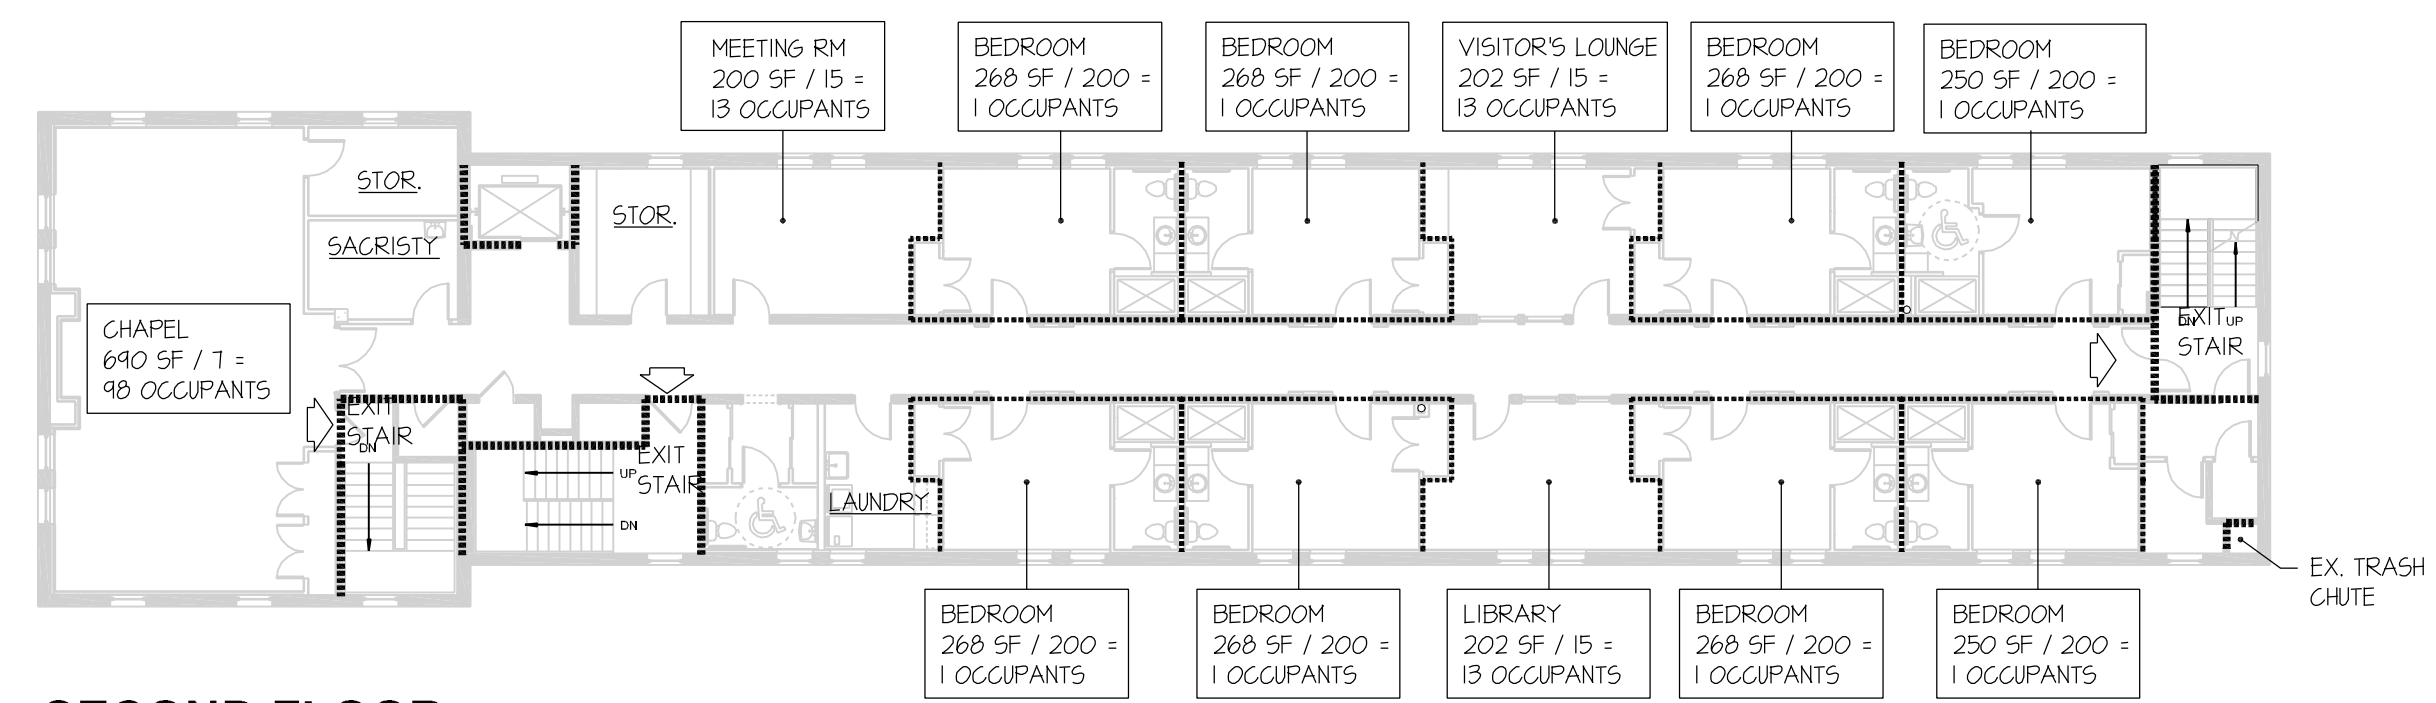

SECOND FLOOR

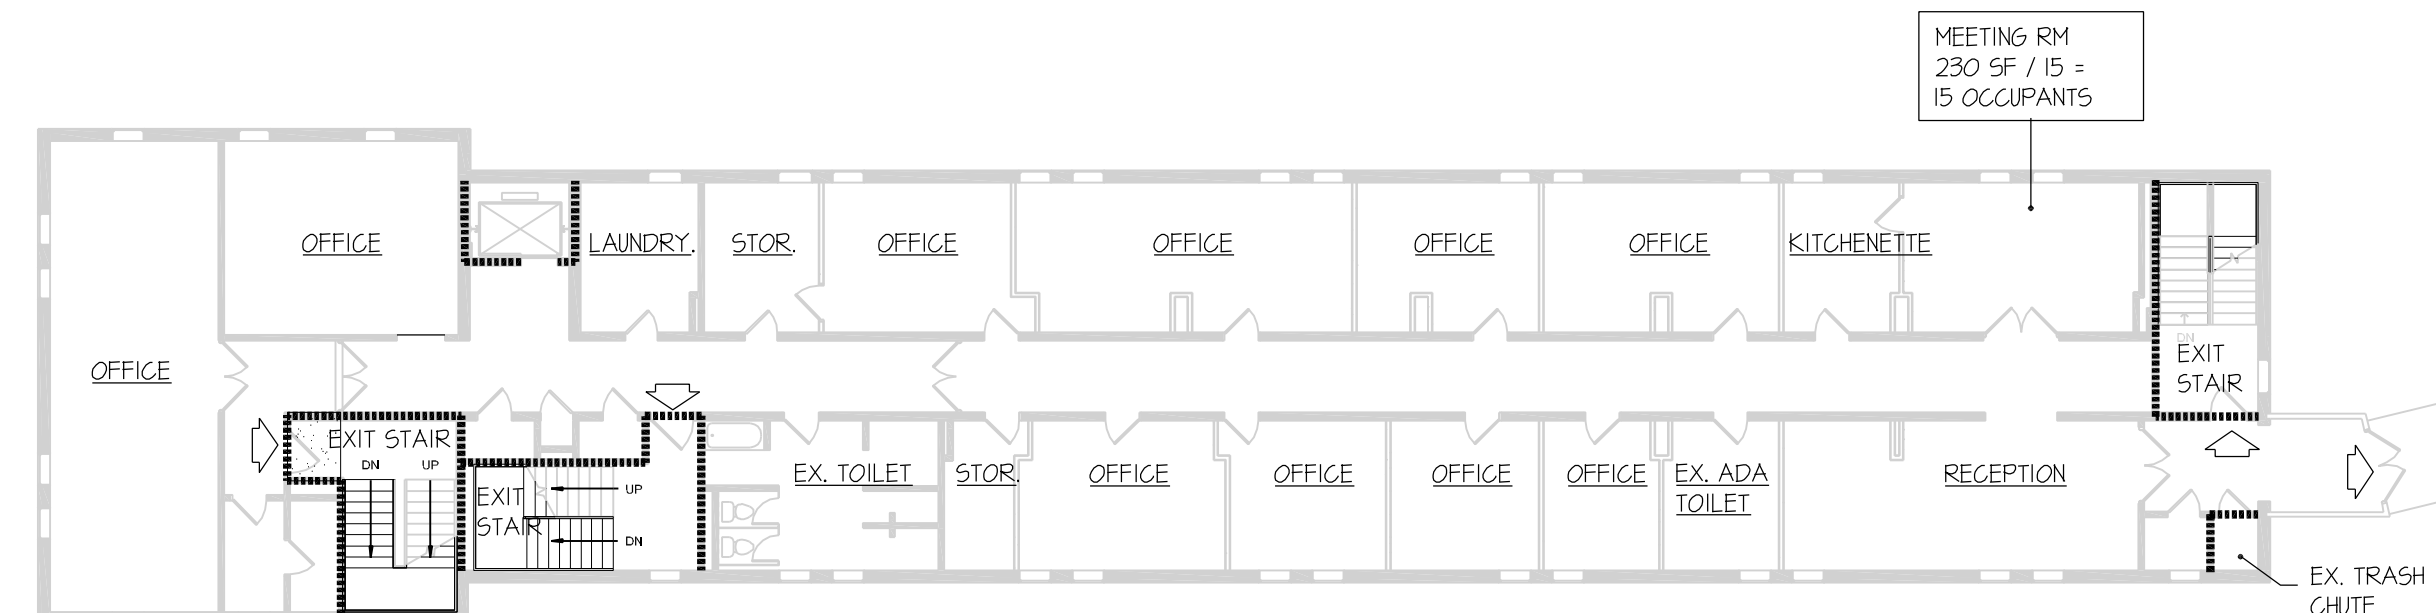

FIRST FLOOR

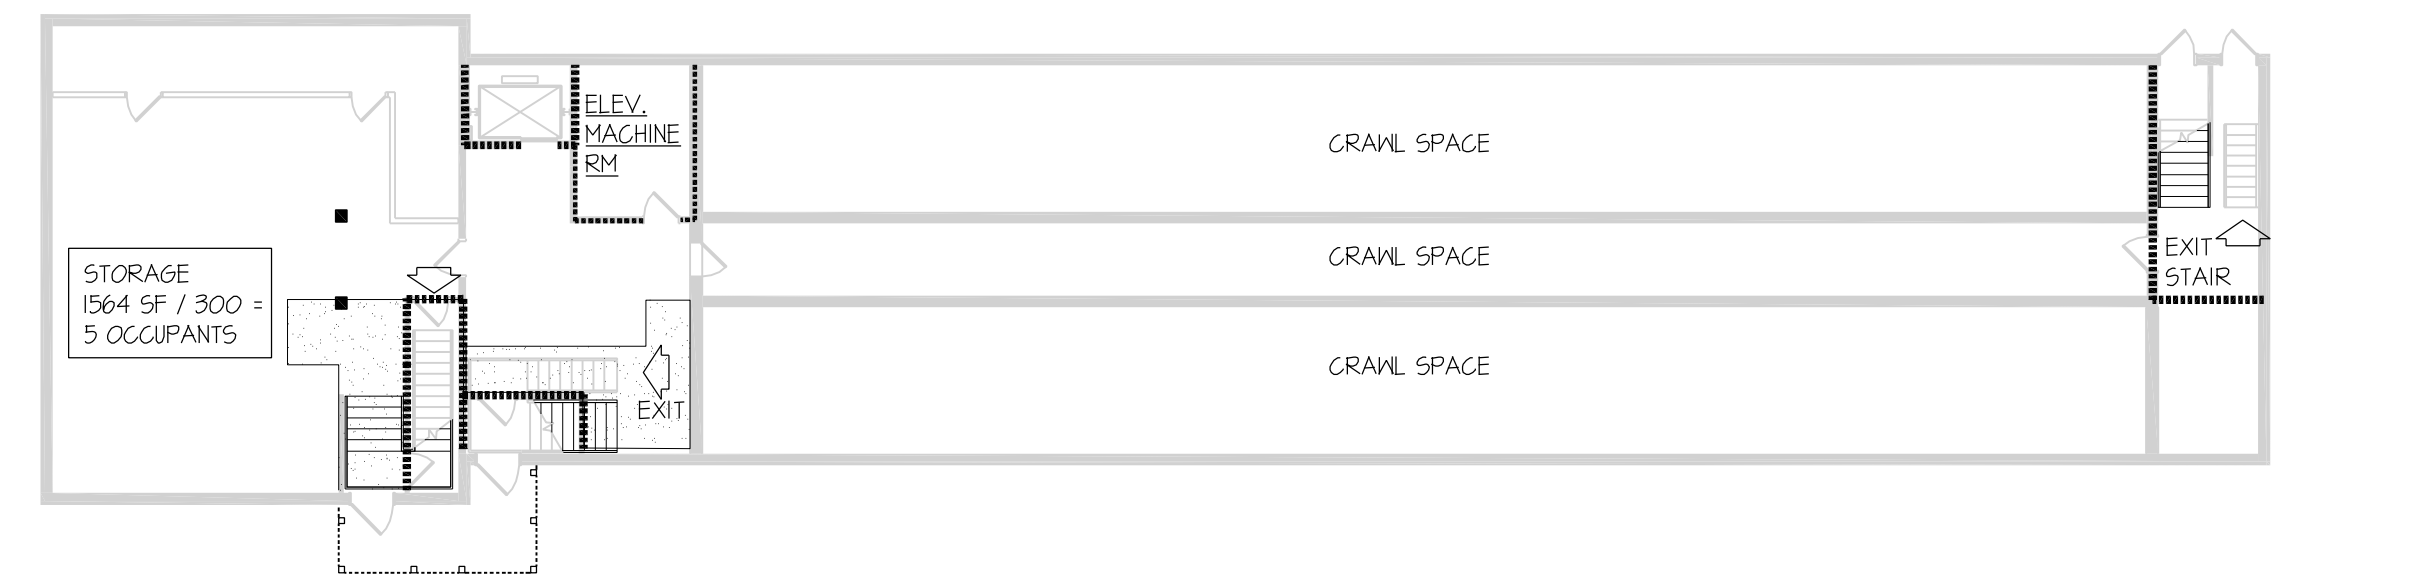

BASEMENT

KEY:

- ONE HOUR WALL
- ONE HOUR FLOOR/ CEILING CONSTRUCTION
- EXIT



810 Light Street Baltimore, Md 21230

Professional Certification: I certify that these documents were prepared or approved by me, and that I am a duly licensed architect under the laws of the State of Maryland.

DGG: License No.9473 Expiration Date:4/7/2015


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1	6-17-13		

REVISIONS


NOTRE DAME PREP CONVENT RENOVATION

CODE ANALYSIS & FIRE PROTECTION PLANS


PROJ. NO.: 13007-00	DWG NO.
DRAWN BY: SRW	G-002
DATE: 06-13-13	

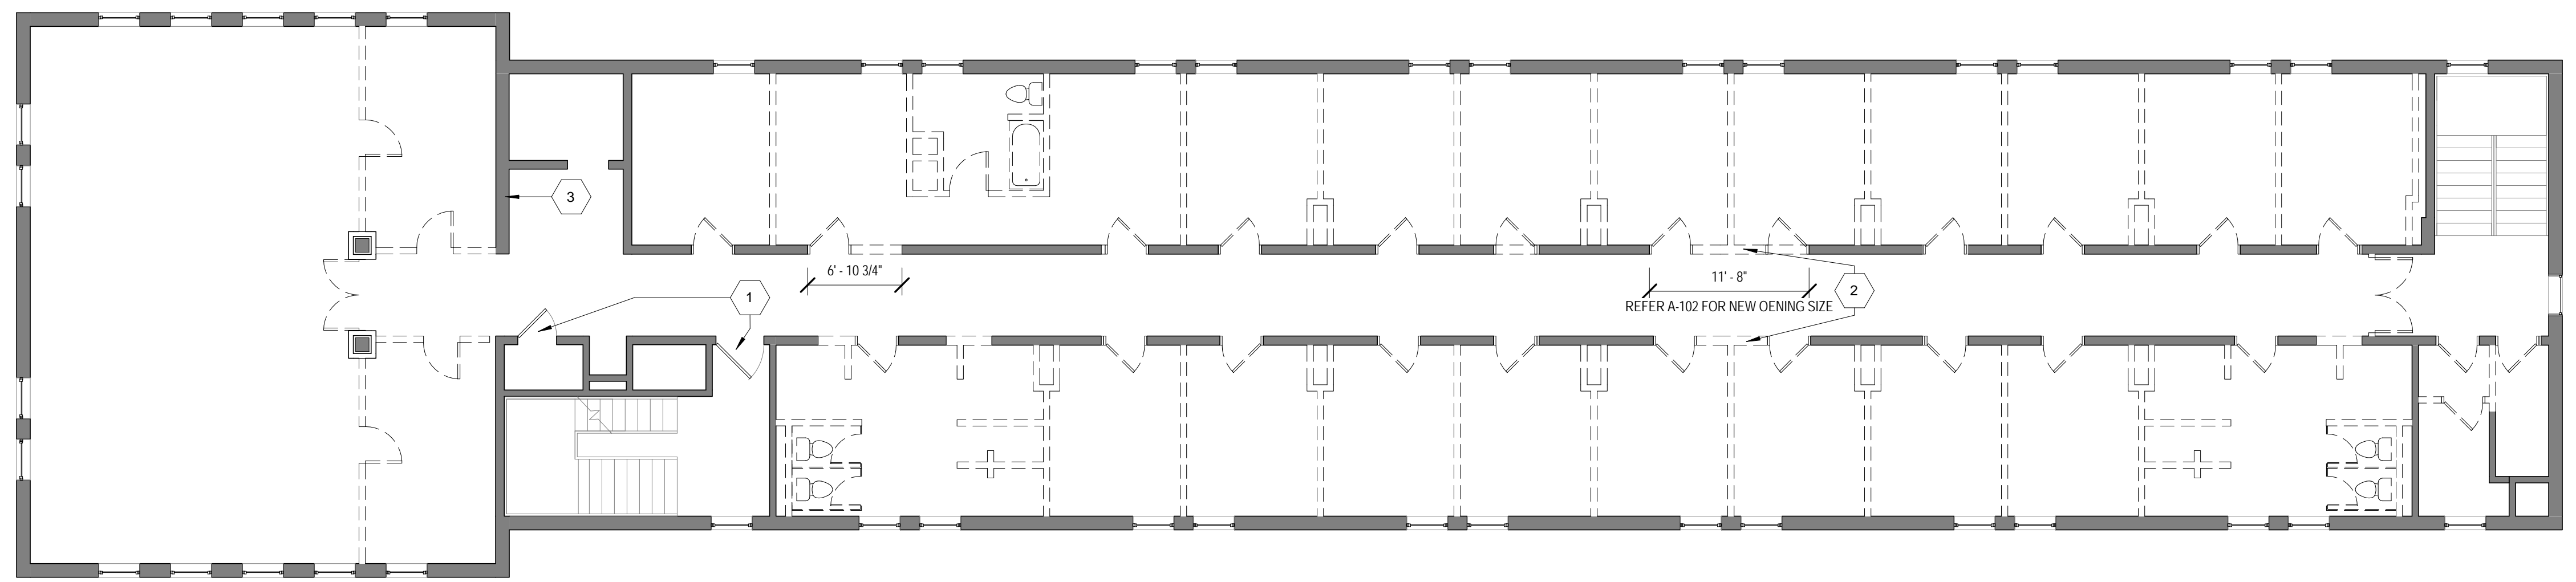


1D THIRD FLOOR DEMOLITION PLAN
1/8" = 1'-0"

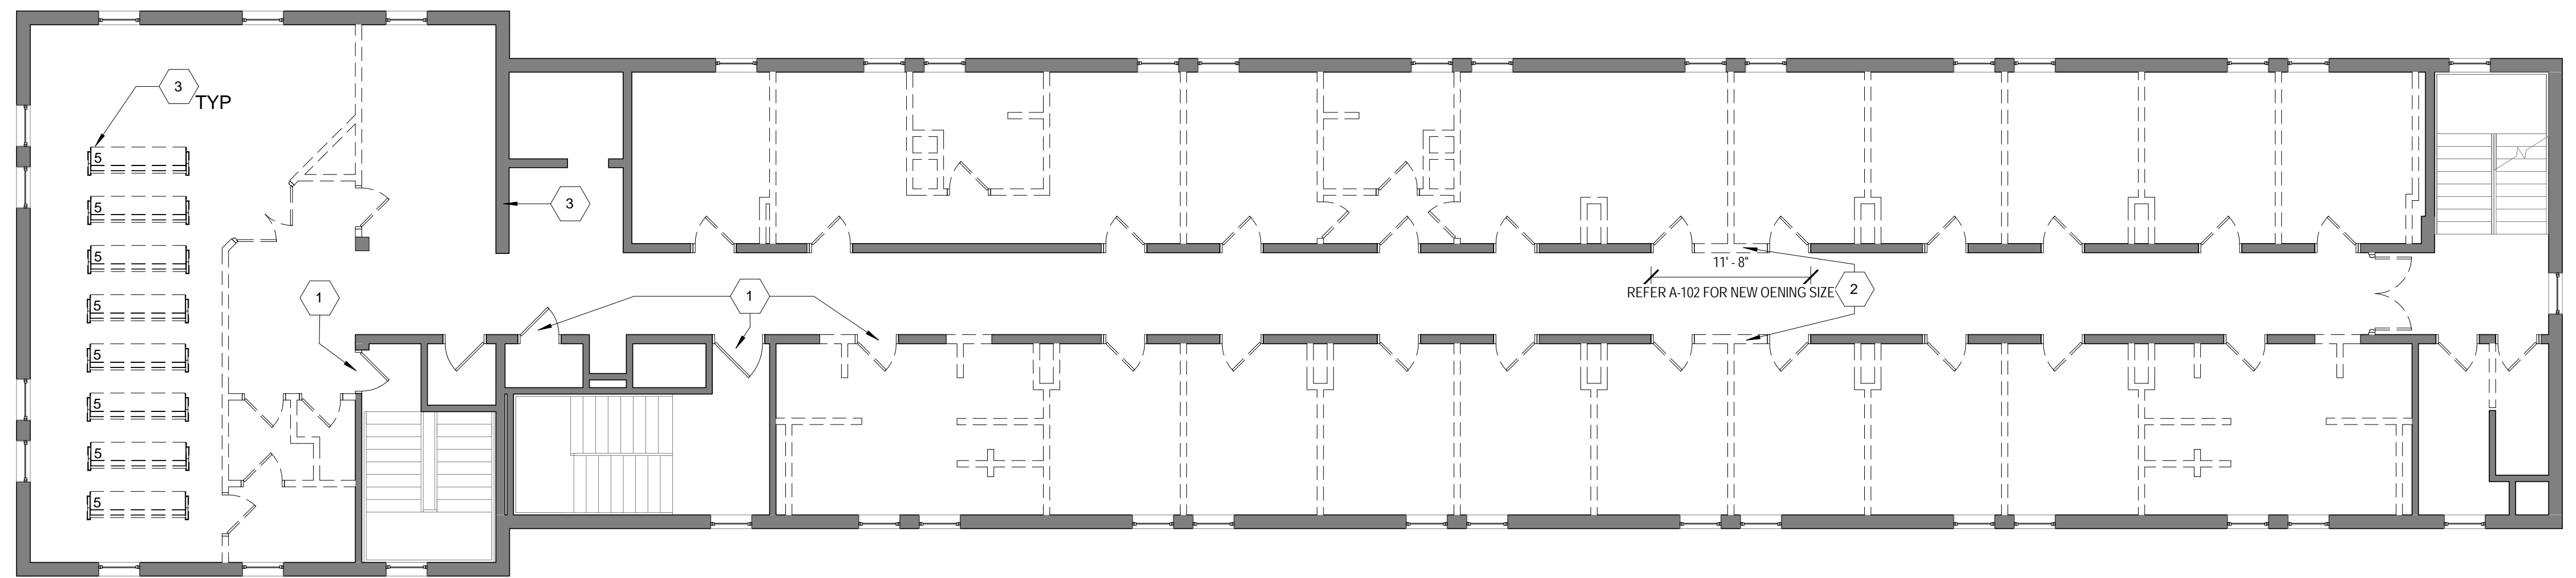

1C SECOND FLOOR DEMOLITION PLAN
1/8" = 1'-0"

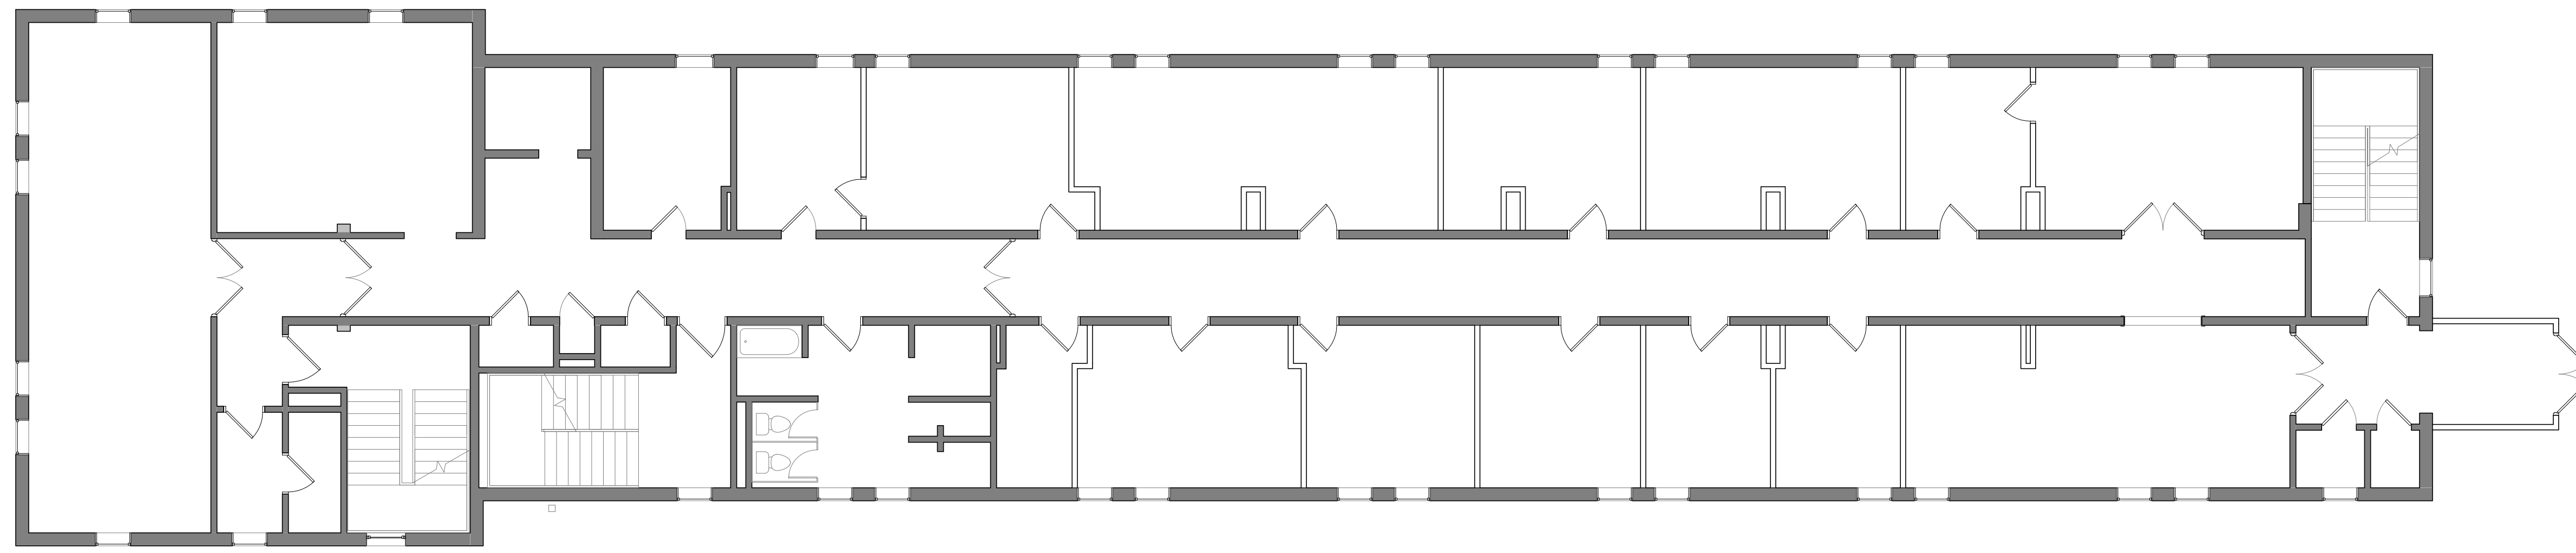

1B FIRST FLOOR DEMOLITION PLAN
1/8" = 1'-0"

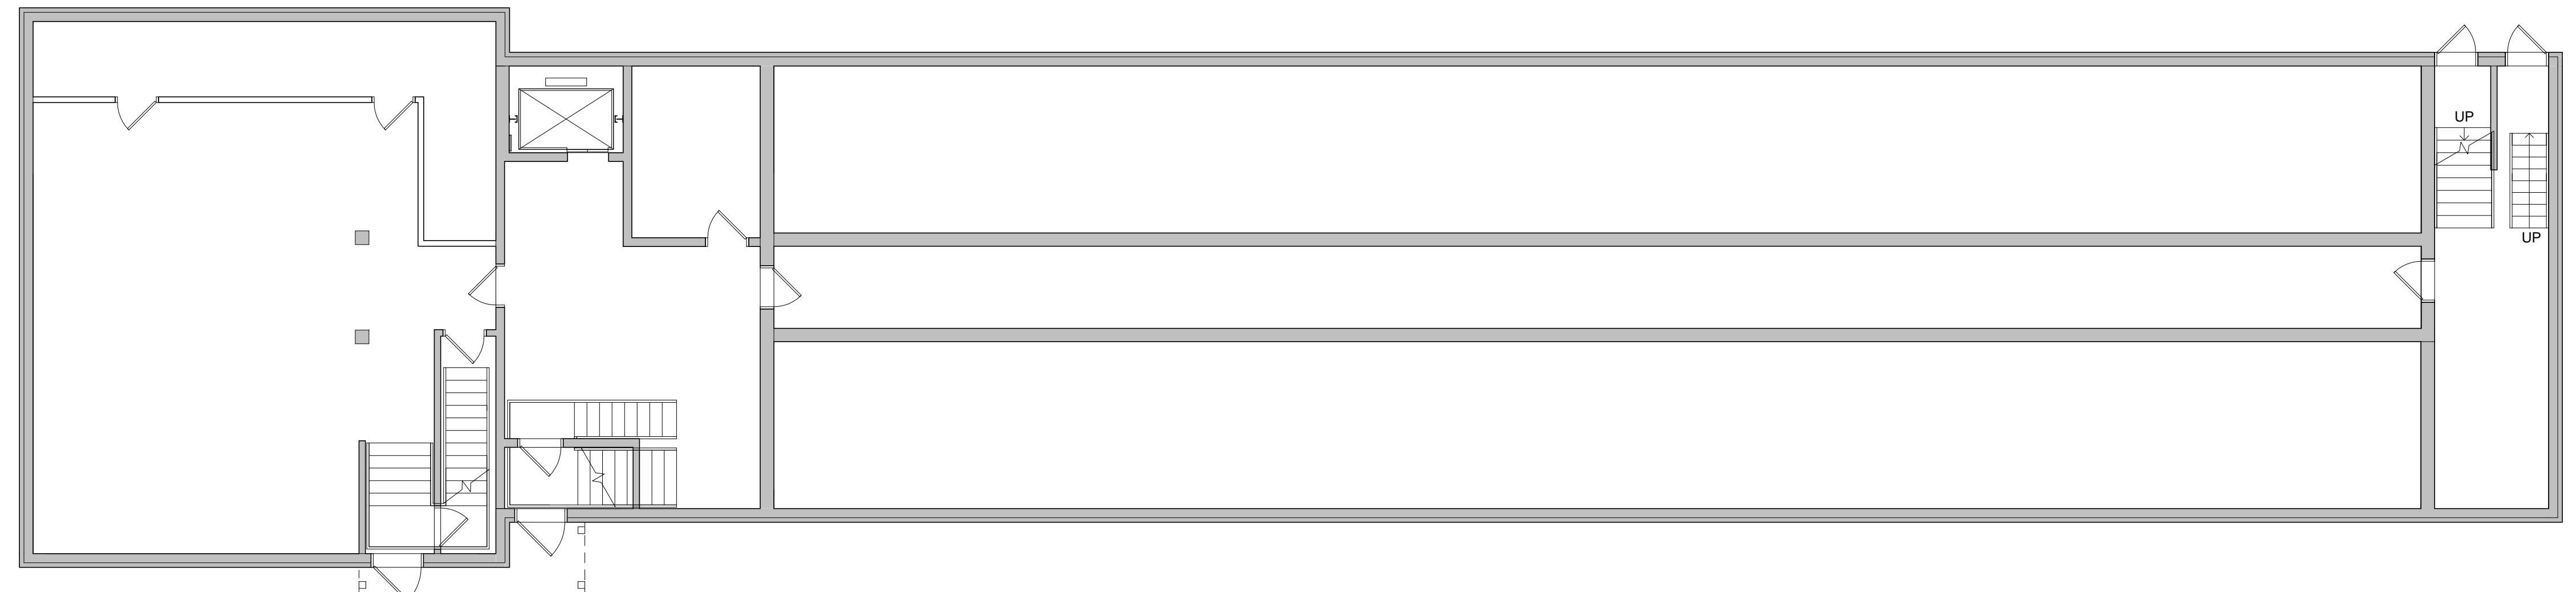

1A BASEMENT FLOOR- DEMOLITION PLAN
1/8" = 1'-0"

DEMOLITION KEYNOTES	
NO.	DESCRIPTION
1	EXISTING DOOR TO REMAIN
2	NEW MASONRY OPENING - PROVIDE NEW LINTEL
3	SALVAGE EXISTING PHONE BOOTHS & PEWS - TURN OVER TO OWNER

- GENERAL NOTES:**
- REMOVE EXISTING FINISHES THROUGHOUT SECOND & THIRD FLOORS UNLESS NOTED OTHERWISE, INCLUDING:
 - CEILINGS
 - FLOORING (MAY CONTAIN ASBESTOS)
 - BASE
 - DRAPERY / BLINDS
 - PANELING
 - REMOVE ALL EXISTING DOORS & FRAMES UNLESS NOTED OTHERWISE
 - REFER TO SHEET A-102 FOR NEW DOOR LOCATIONS IN EXISTING BEARING WALL. REUSE EXISTING LINTEL LOCATIONS WHERE FEASIBLE. PROVIDE FINISHED MASONRY OPENINGS FOR NEW 3'-0" DOORS, TYP
 - EXISTING STAIR RAILINGS TO REMAIN
 - REMOVE ALL EXISTING PLUMBING FIXTURES & MECHANICAL UNITS. CAP PIPING WHERE ABANDONED
 - PATCH CONCRETE SLAB WHERE PIPES ARE REMOVED/ ABANDONED
 - EXISTING ELEVATOR TO BE REFINISHED (NEW CAB FINISHES & CONTROLS)

LEGEND

	EXISTING PARTITION TO BE REMOVED
	EXISTING PARTITION TO REMAIN



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NO	DATE	DESCRIPTION
1	06-17-13	PERMIT SET

REVISIONS

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DEMOLITION PLAN

PROJ. NO.: 13007-00	DWG NO.
DRAWN BY: AR	D-101
DATE: 06-13-13	

6/18/2013 11:41:55 AM



PARTITION SCHEDULE

	FIRE RATING - UL#	STC RATING	HEIGHT
1	---	---	TO UNDERSIDE OF DECK/STRUCTURE ABOVE.
2	---	---	TO UNDERSIDE OF DECK/STRUCTURE ABOVE.
2A	---	---	TO UNDERSIDE OF DECK/STRUCTURE ABOVE.
3	1HR - U906	---	TO UNDERSIDE OF DECK/STRUCTURE ABOVE.
3A	1HR - U906	---	TO UNDERSIDE OF DECK/STRUCTURE ABOVE.
4	1HR - U419	50 STC	TO UNDERSIDE OF DECK/STRUCTURE ABOVE.
5	1HR - U419	50 STC	TO UNDERSIDE OF DECK/STRUCTURE ABOVE.
5A	50 STC	---	TO UNDERSIDE OF DECK/STRUCTURE ABOVE.
6	1HR - U419	50 STC	TO UNDERSIDE OF DECK/STRUCTURE ABOVE.


PARTITION NOTES

- ALL GYP BD IN LAUNDRY ROOM, TOILETS & BATHROOMS SHALL BE MOISTURE / MOLD RESISTANT.
- ALL FIRE RATED SOUND BATT INSULATION SHALL BE THERMAFIBER OR ROXUL ROCK WOOL.
- CORRIDOR WALLS @ TYPE 3, TYP
- EXTERIOR WALLS ARE TYPE 1, TYP
- DEMISING WALLS BETWEEN BEDROOMS ARE TYPE 4, TYP
- WET WALLS AT TOILETS ARE TYPE 5 OR 6A (SEE PLAN)

PARTITION HEAD DETAILS

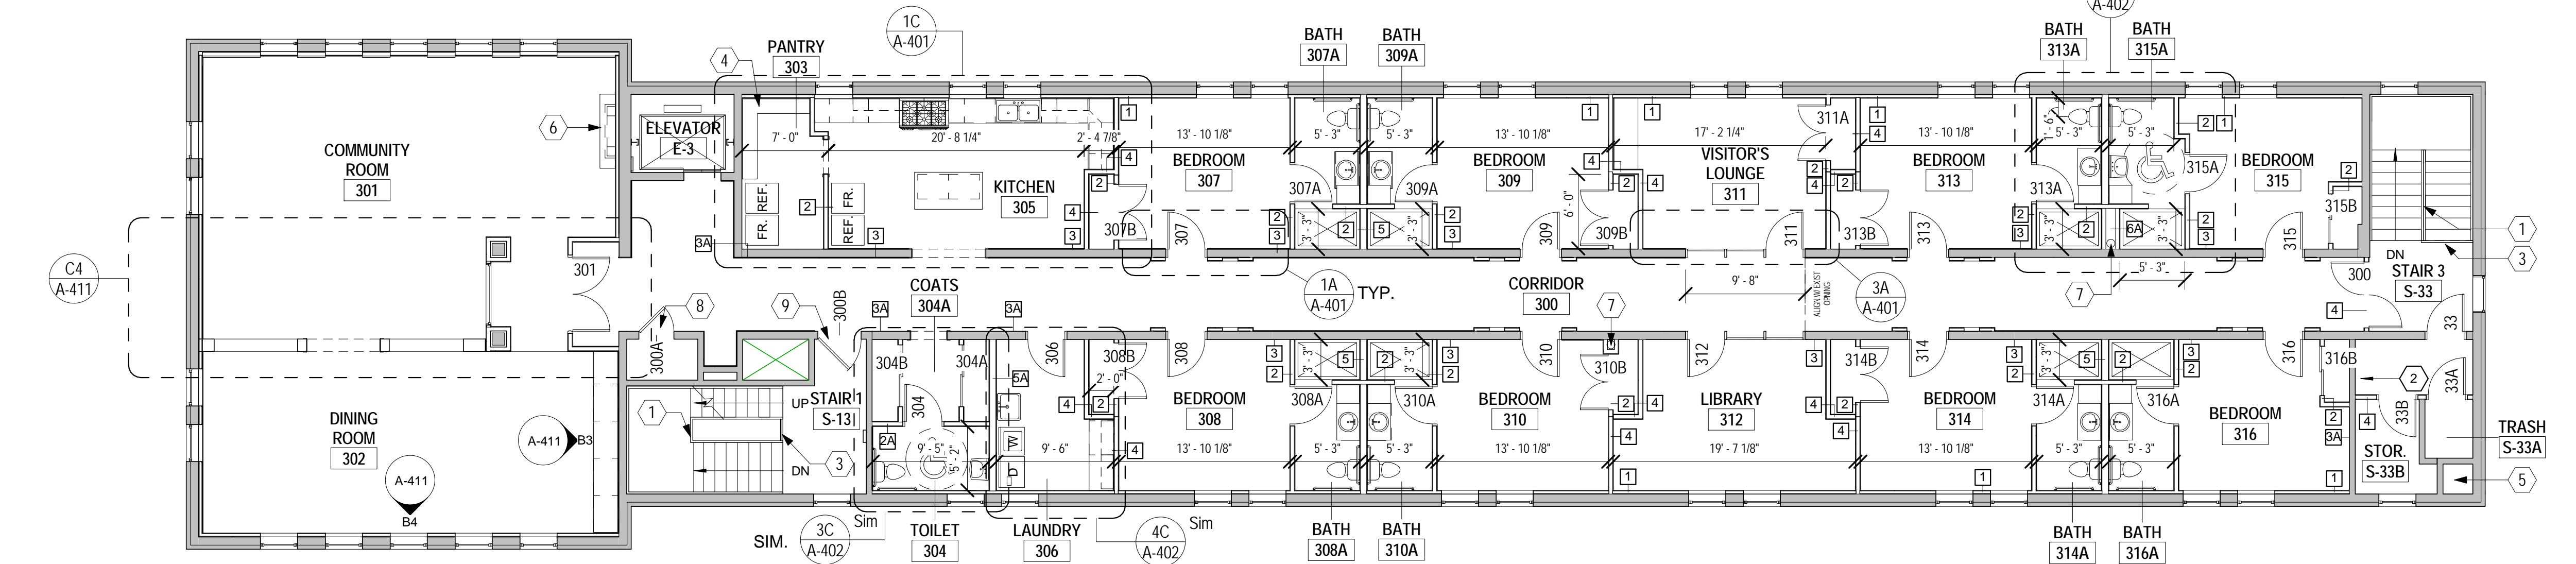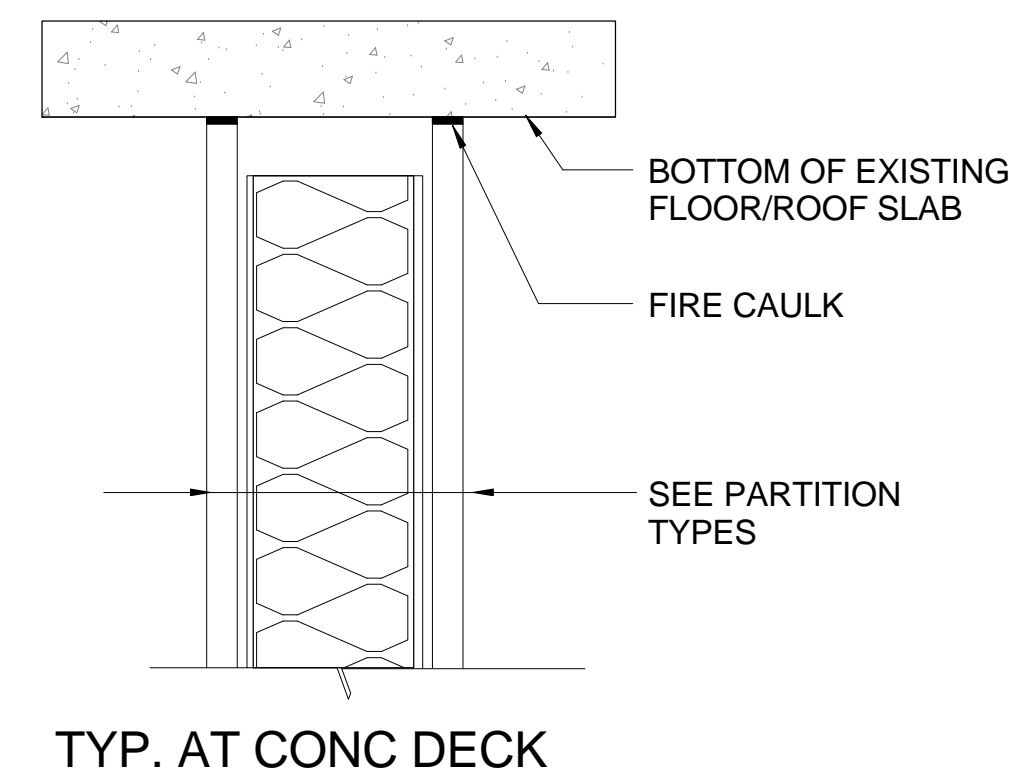

2C THIRD FLOOR PLAN
1/8" = 1'-0"

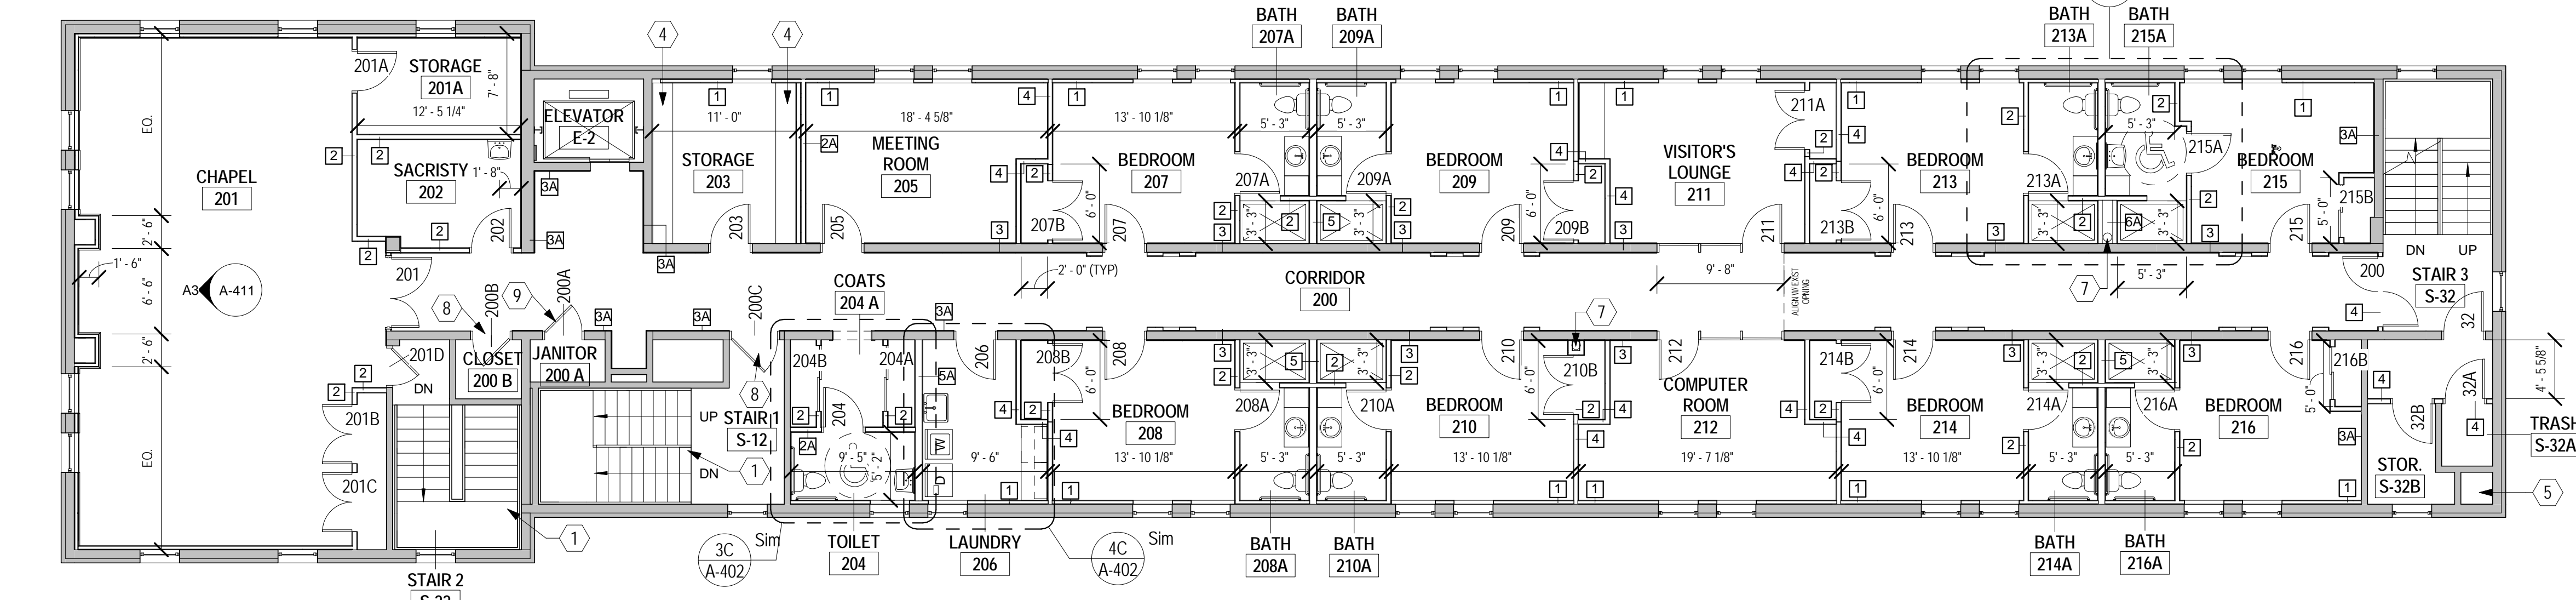

2B SECOND FLOOR PLAN
1/8" = 1'-0"

FLOOR PLAN KEYNOTES

NO	DESCRIPTION
1	CONTRACTOR TO INSTALL (2) ADDITIONAL HORIZONTAL RAILS @ STAIR GUARD (TO PROVIDE 4 EQ. SPACES) RAIL DESIGN TO MATCH EXISTING
2	PAINT EXISTING ROOF LADDER
3	EXTEND GUARD RAIL TO 36" HT
4	ADJUSTABLE P LAM SHELVING ON HD BRACKETS
5	EXISTING TRASH CHUTE TO REMAIN
6	GAS FIREPLACE WITH MANTEL (ADD ALTERNATE)
7	EXISTING RAIN LEADER TO REMAIN
8	PAINT EXISTING DOOR
9	PAINT EXISTING DOOR, PROVIDE NEW HARDWARE HW-5

GENERAL NOTES

- CLOSETS SHALL BE 2'-0" DEEP UNLESS DIMENSIONED OTHERWISE.
- PROVIDE PT BLOCKING FOR ALL WALL MOUNTED SHELVES, CABINETS ETC.
- ALL HAZMAT MATERIAL WILL BE REMOVED BY OTHERS OUTSIDE THIS CONTRACT. CONTRACTOR TO NOTIFY THE ARCHITECT IF ANY HAZMAT MATERIAL ARE FOUND.
- EXISTING ELEVATOR CAB TO BE REFURBISHED AS PART OF THIS CONTRACT. ELEVATOR & SHAFT SHALL BE UPGRADED TO MEET ALL APPLICABLE CODES.
- BEDROOM CLOSETS & COAT CLOSETS SHALL RECEIVE COAT ROD & SHELF.
- ALL SHOWER UNITS IN BATHROOMS SHALL RECEIVE GRAB BARS & CURTAIN RODS REFER 1C/ A-402



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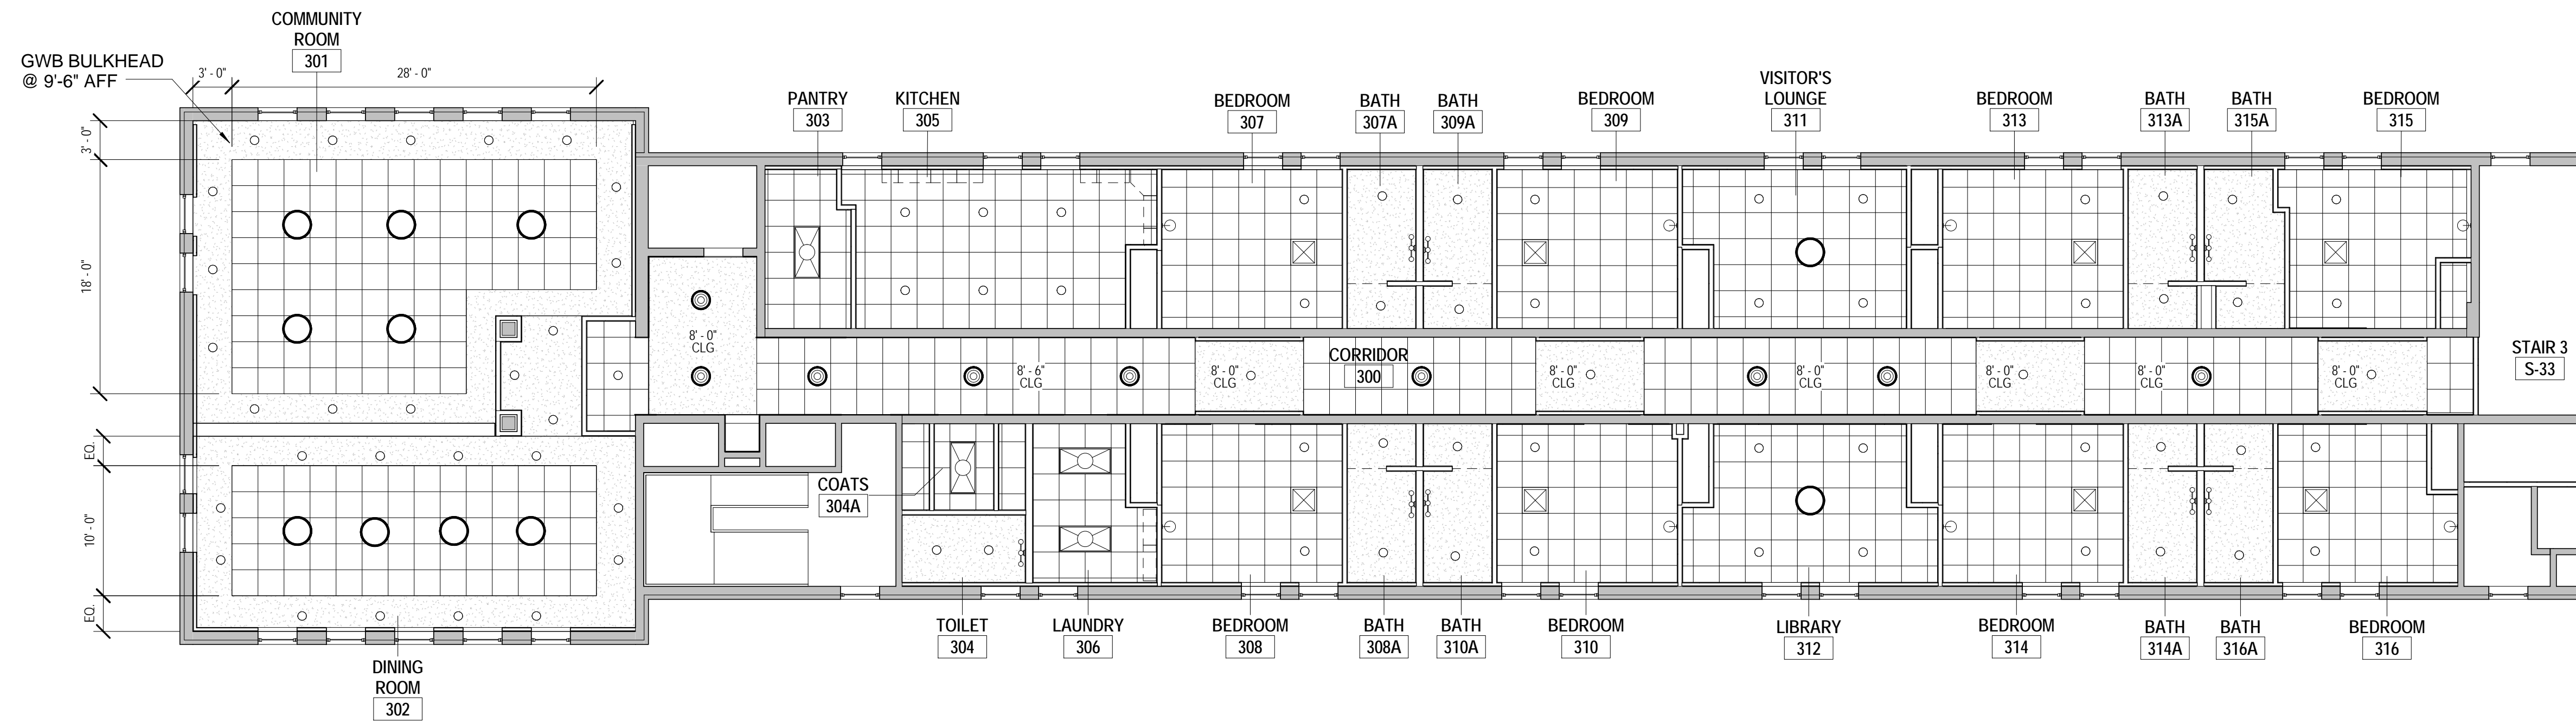
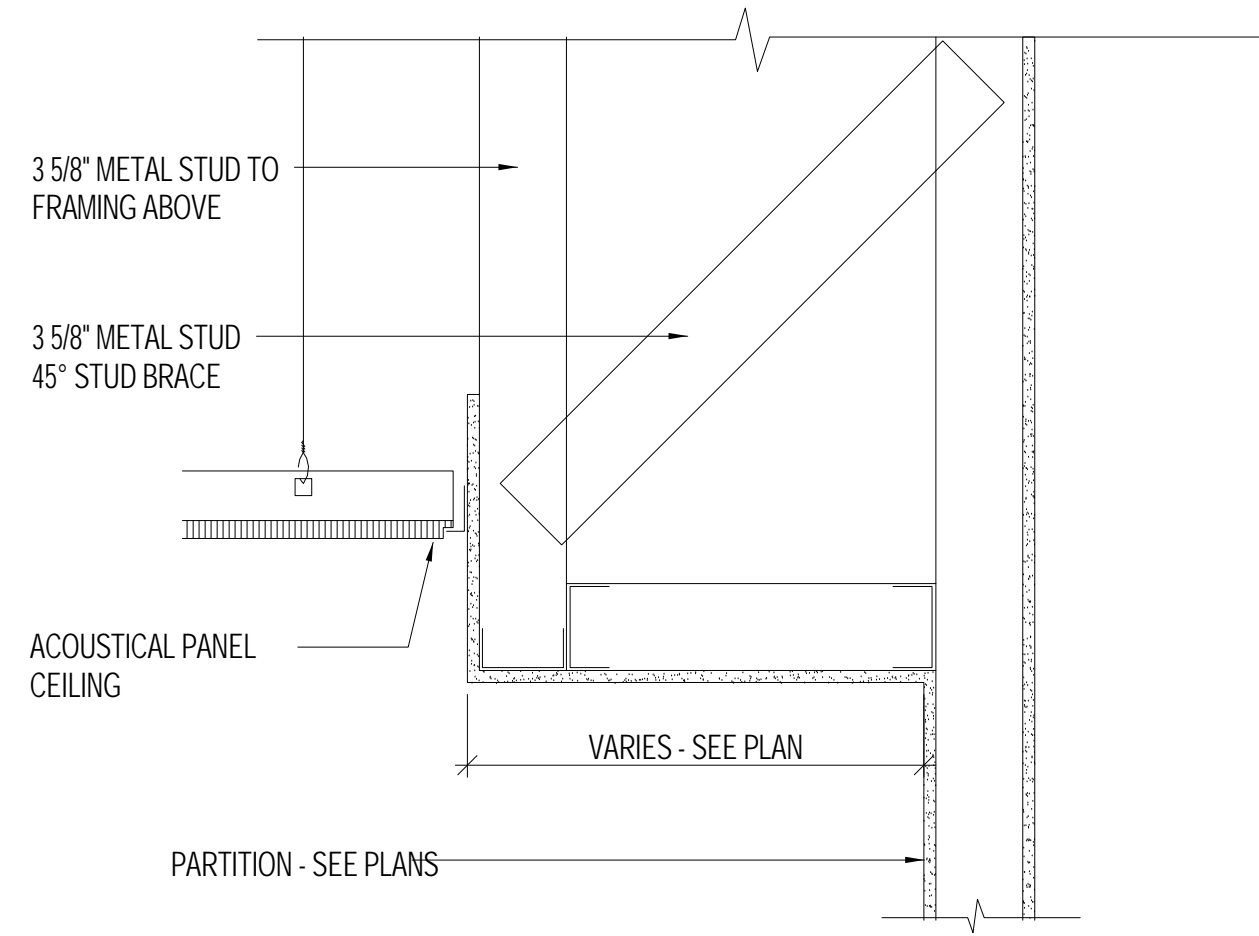
NO	DATE	PERMIT SET DESCRIPTION
1	06-17-13	PERMIT SET

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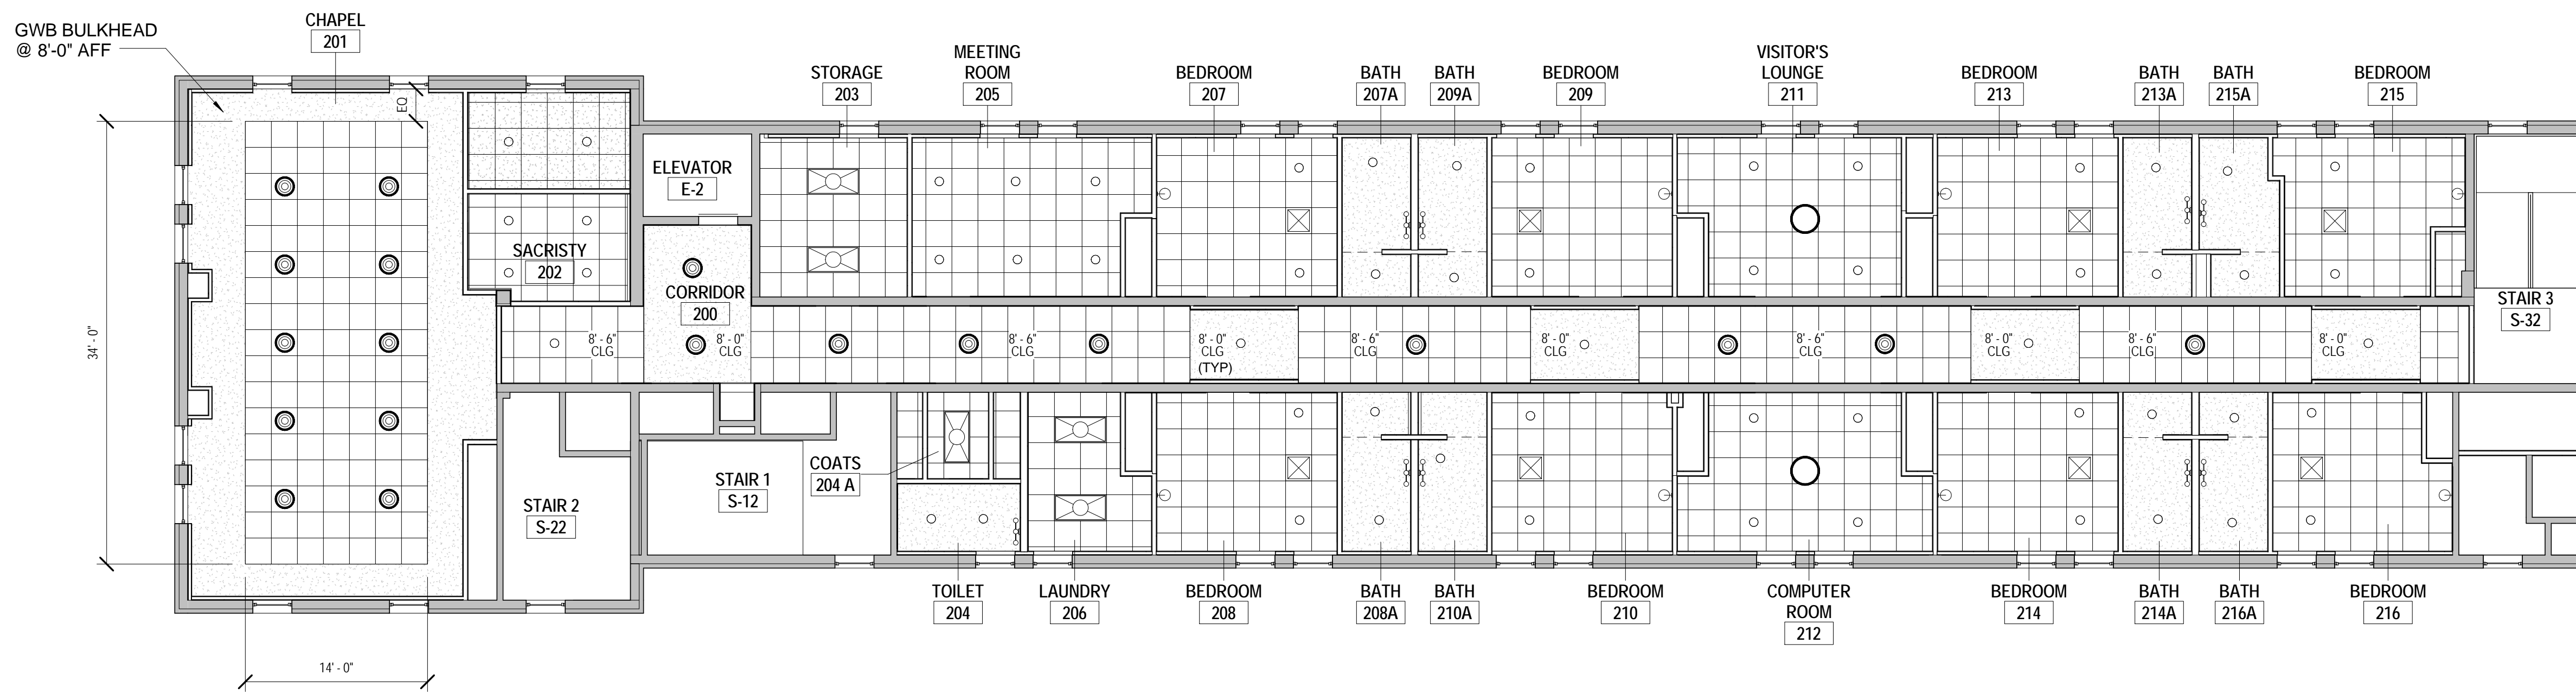
SECOND & THIRD FLOOR PLANS

PROJ. NO.: 13007-00	DWG NO:
DRAWN BY: AR	A-102
DATE: 06-13-13	

1D TYPICAL CEILING DETAIL-1
1 1/2" = 1'-0"



2D THIRD FLOOR
1/8" = 1'-0"



2C SECOND FLOOR
1/8" = 1'-0"

GENERAL CEILING NOTES:

1. LIGHTS IN SHOWERS/ BATH SHALL BE LENSED. RATED FOR WET LOCATIONS
2. COAT CLOSETS SHALL RECEIVE A WALL LIGHT THAT IS OPERATED BY OPENING THE CLOSET DOOR
3. BEDROOM CEILINGS TO BE 8'-6" +/- AFF
4. BATHROOM CEILINGS TO BE 8'-0" AFF

RCP LEGEND

- RECESSED DOWNLIGHT
- PENDANT LIGHT A
- CEILING MTD LIGHT B
- WALL MTD LIGHT B
- RECESSED LIGHT 2'X4'
- VANITY LIGHT-WALL MOUNTED
- SHOWER CURTAIN ROD
- CEILING MTD VRV CASSETTE UNIT -2'X2'
- PTD GWB
- 2 X 2 ACOUSTIC CEILING ARMSTRONG DUNE W/ 9/16" GRID



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1	06-17-13	PERMIT SET

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REFLECTED CEILING PLAN

PROJ. NO.: 13007-00	DWG NO. A-112
DRAWN BY: AR	
DATE: 06-13-13	


GENERAL NOTES

- ALL FLOOR FINISHES CONTINUE UNDER CASEWORK, FF&E.
- CHANGES IN FLOOR FINISHES OCCUR AT CENTER OF DOORS.
- SEPARATE CHANGES IN FLOOR FINISHES W/ APPROPRIATE VINYL TRANSITION STRIPS.
- FLOOR PATTERNS TO BE CENTERED WITHIN ROOM UNLESS DIMENSIONED/ NOTED OTHERWISE.
- ALL CLOSETS SHALL GET THE SAME FLOOR FINISH AS THE ADJACENT ROOM UNLESS OTHERWISE SPECIFIED.
- WHERE FLOOR FINISHES ARE NOT SHOWN IN THE FINISHES PLAN, PLEASE REFER TO THE FINISH SCHEDULE/ SPECIFICATIONS FOR CLARIFICATION OF FLOOR FINISHES.
- PROVIDE ADA ACCESSIBLE MARBLE THRESHOLD AT ALL TOILET ROOMS, TYP.


FINISH KEY

- CARPET - CPT
- CPT-1 [CORRIDOR FIELD CARPET]
 - CPT-2 [LEAF PATTERN CARPET]
 - CPT-3 [FLORAL PATTERN CARPET]
 - CPT-6 [CORRIDOR CARPET BORDER]
 - CPT-7 [CHAPEL & CORRIDOR CARPET BORDER]

- VINYL PLANK - VP
- VP - 1 [MAIN FLOORING]
 - VP - 2 [ACCENT STRIPES IN DINING ROOM]

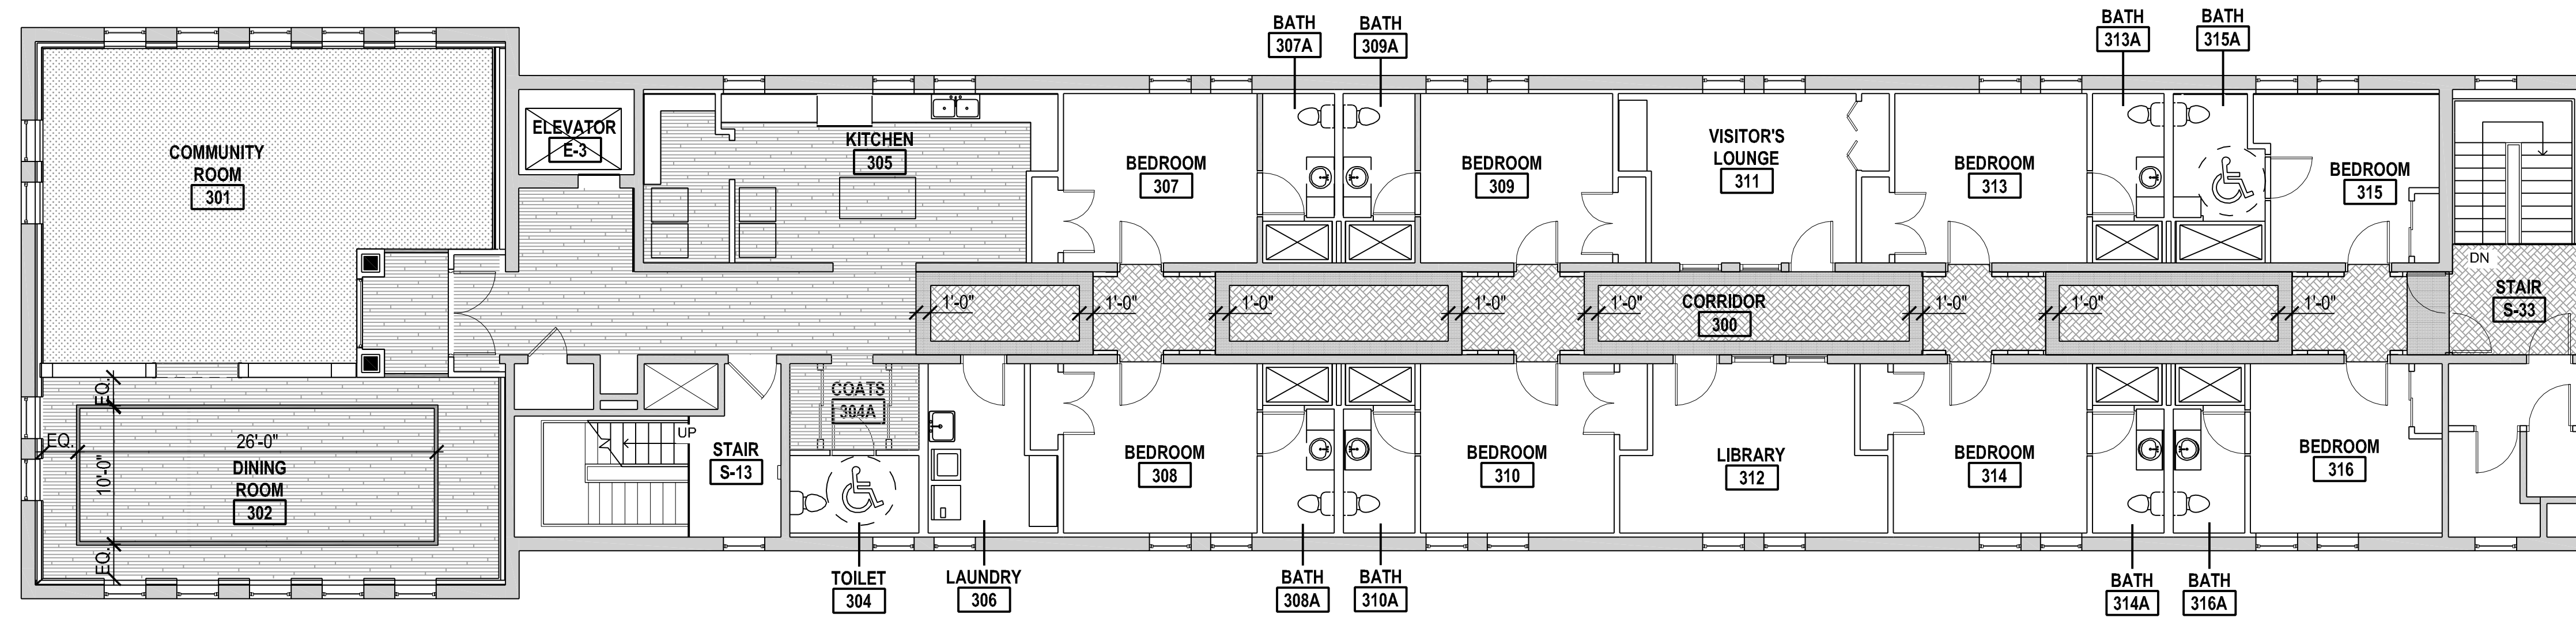

2C THIRD FLOOR FINISH PLAN
1/8" = 1'-0"

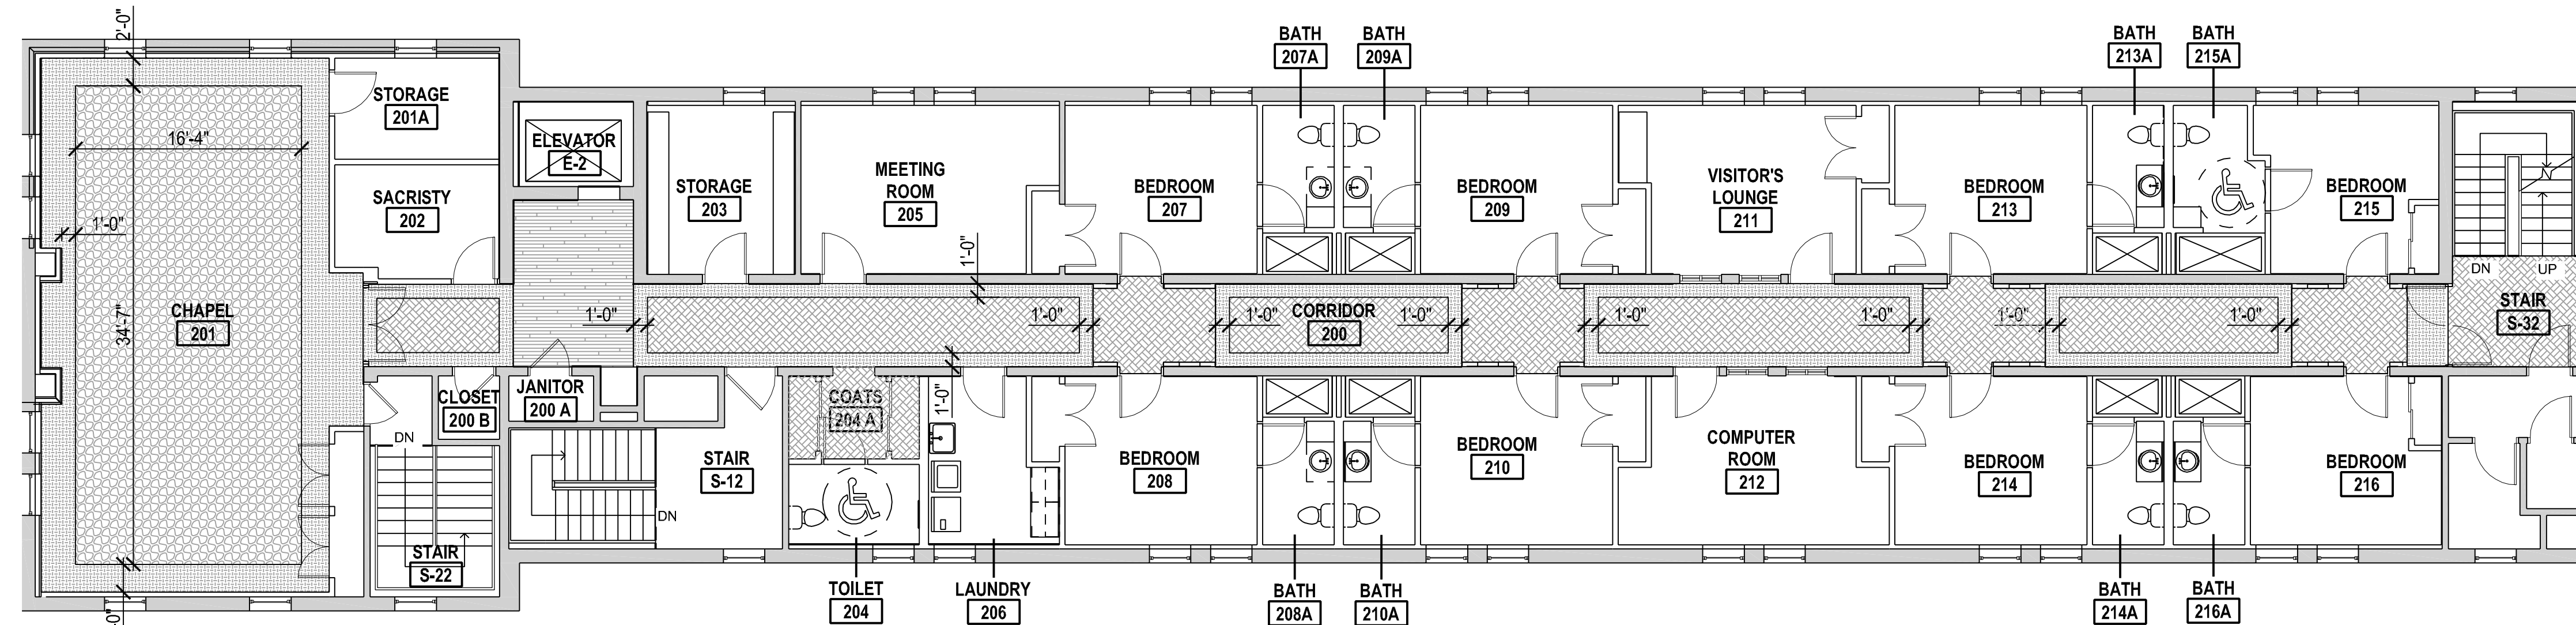

2B SECOND FLOOR FINISH PLAN
1/8" = 1'-0"



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1	6-17-13	PERMIT SET

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**SECOND & THIRD
FLOOR FINISH
PLANS**

PROJ. NO.: 13007-00	DWG NO
DRAWN BY: AR	A-122
DATE: 06-13-13	


NO	DATE	DESCRIPTION
1	06-17-13	PERMIT SET

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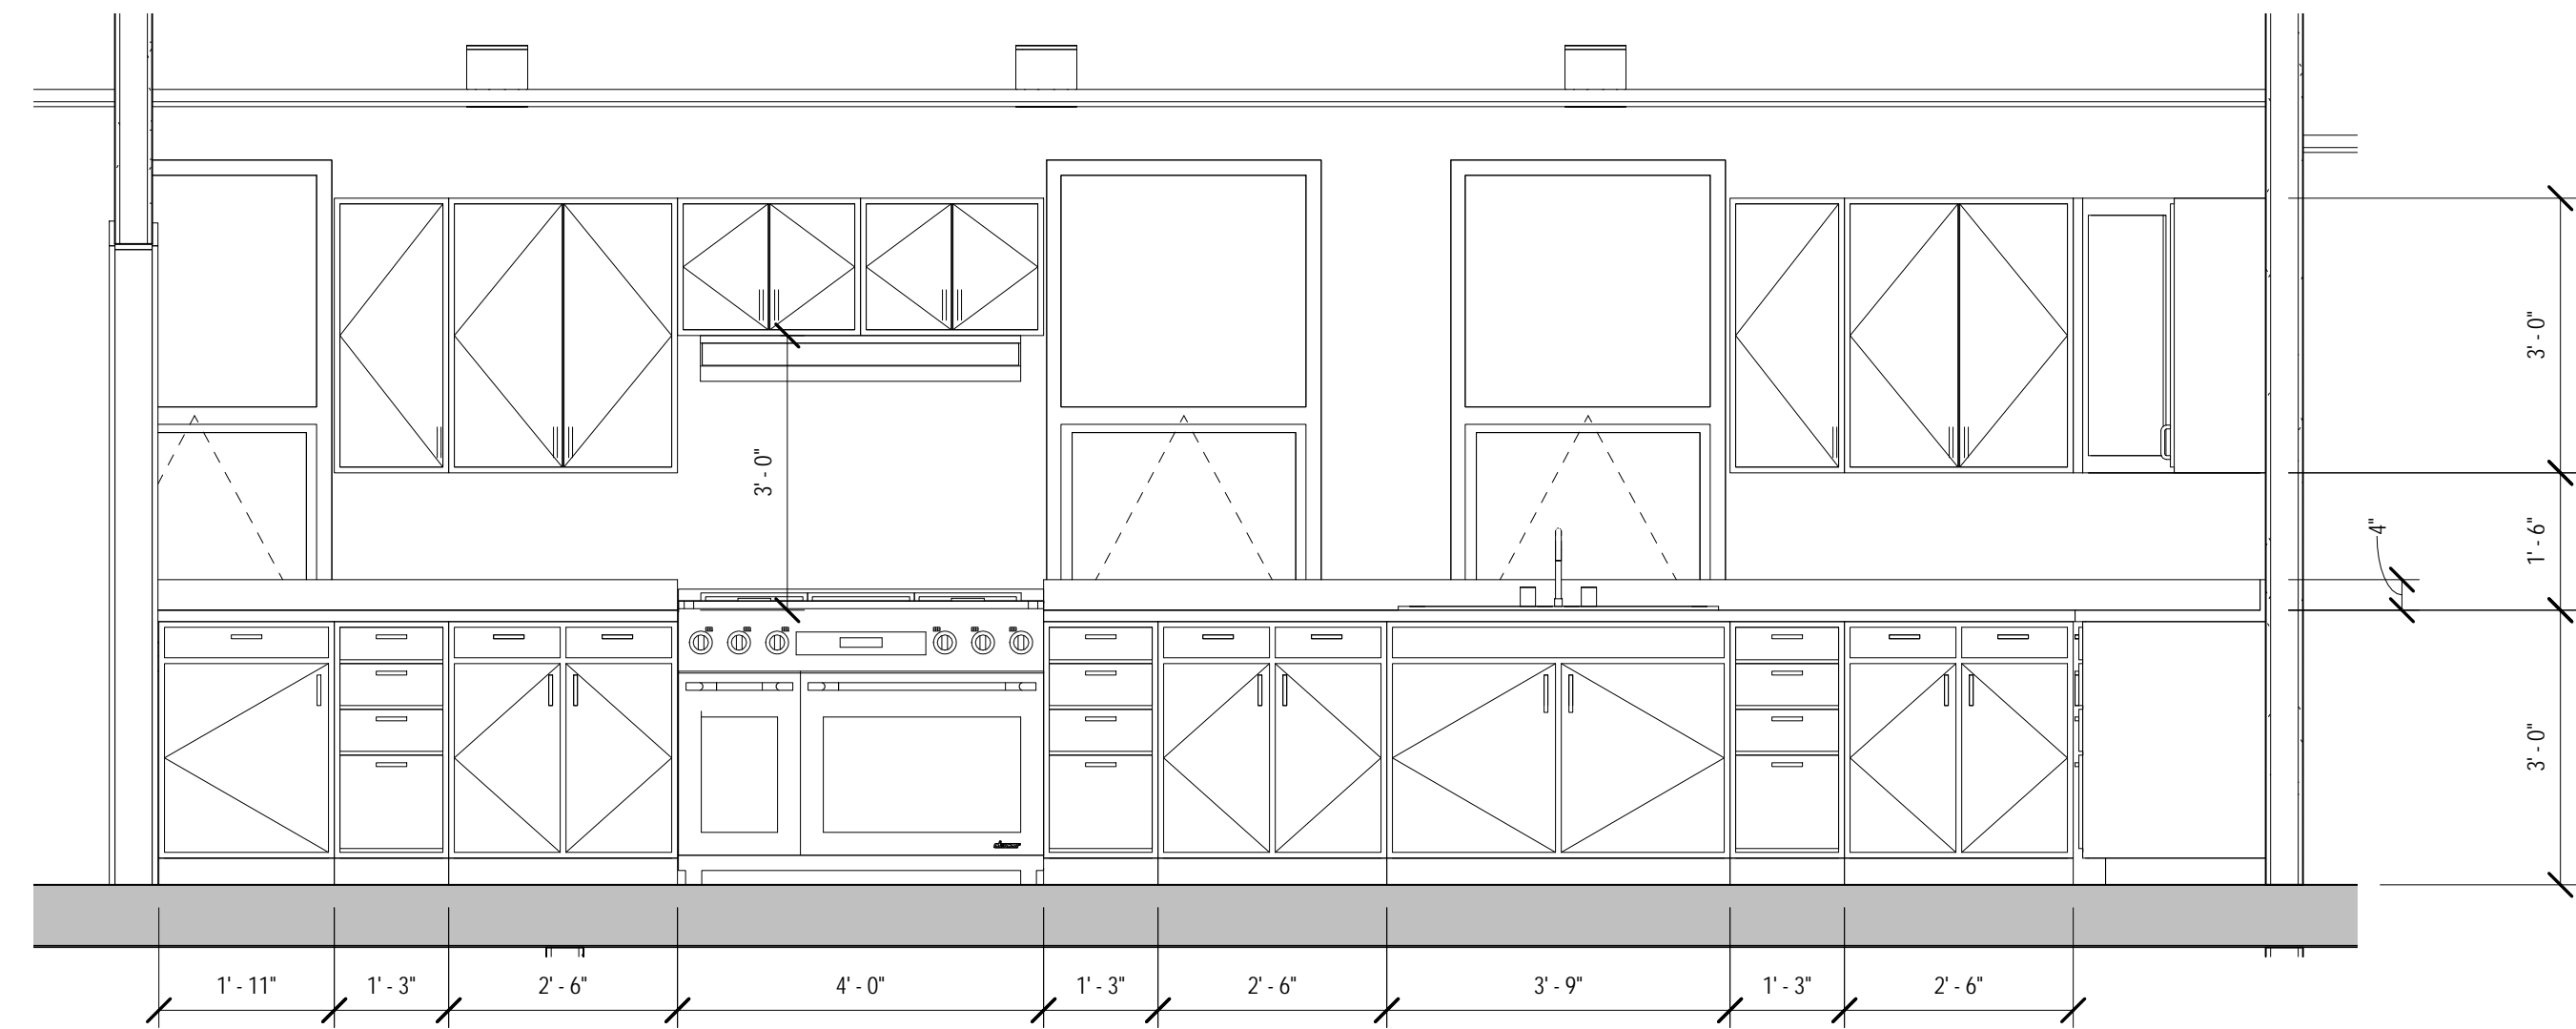
**NOTRE DAME
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RENOVATION**

**ENLARGED FLOOR
PLANS & DETAILS**


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DRAWN BY: AR	A-401
DATE: 06-13-13	

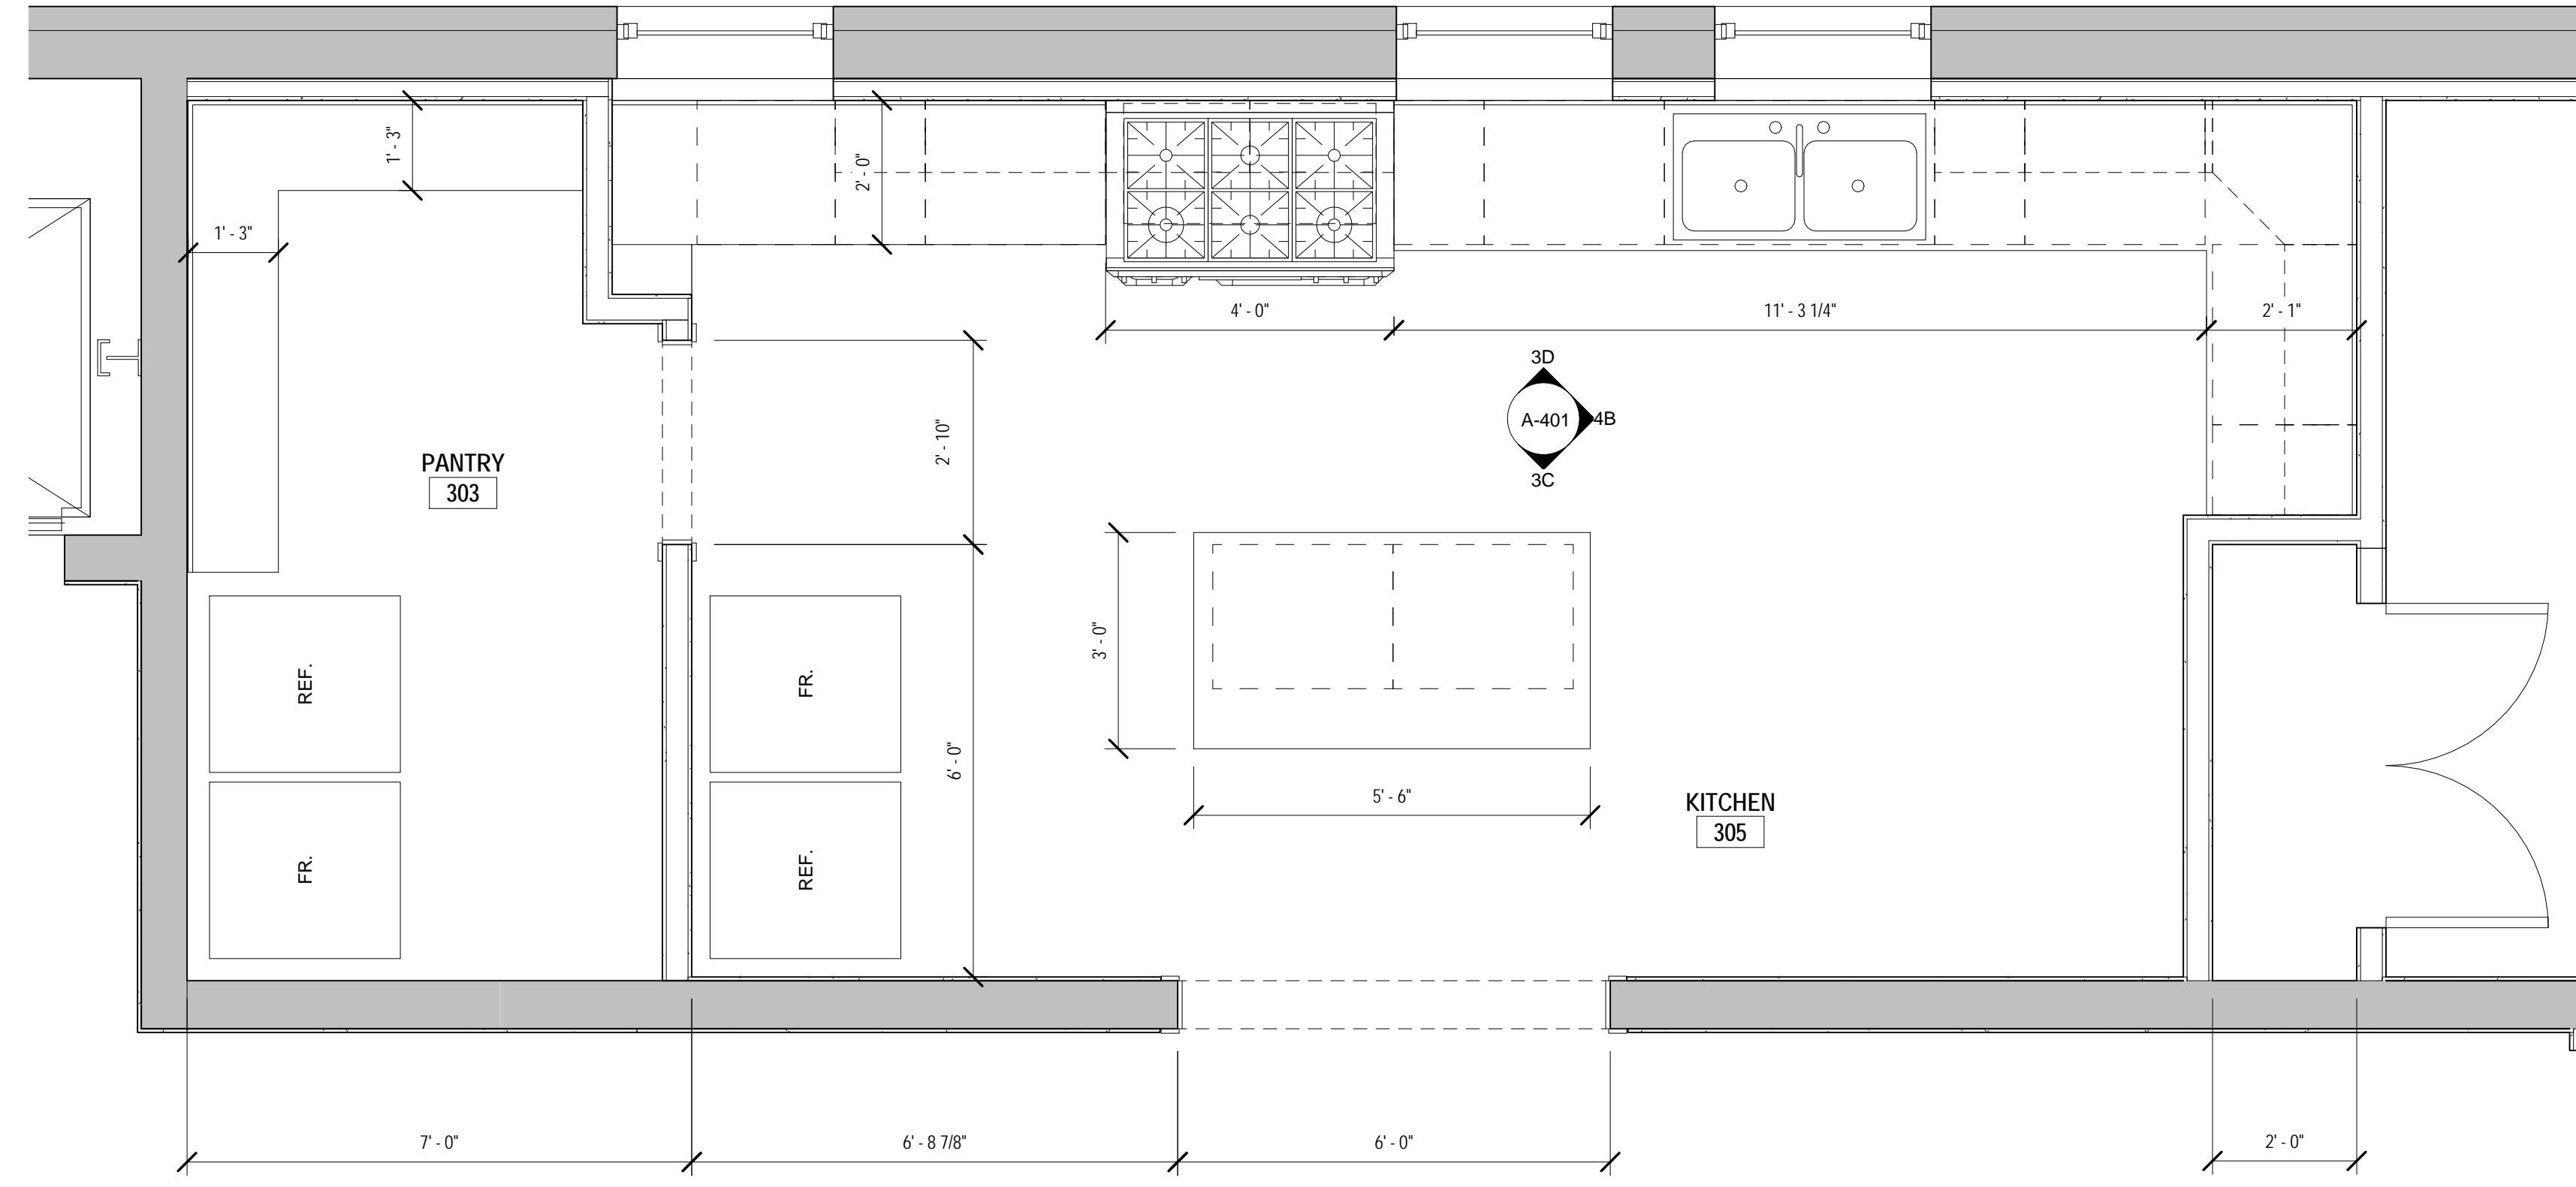


1C ENLARGED FLOOR PLAN-KITCHEN
1/2" = 1'-0"




3D KITCHEN ELEVATION-1
1/2" = 1'-0"

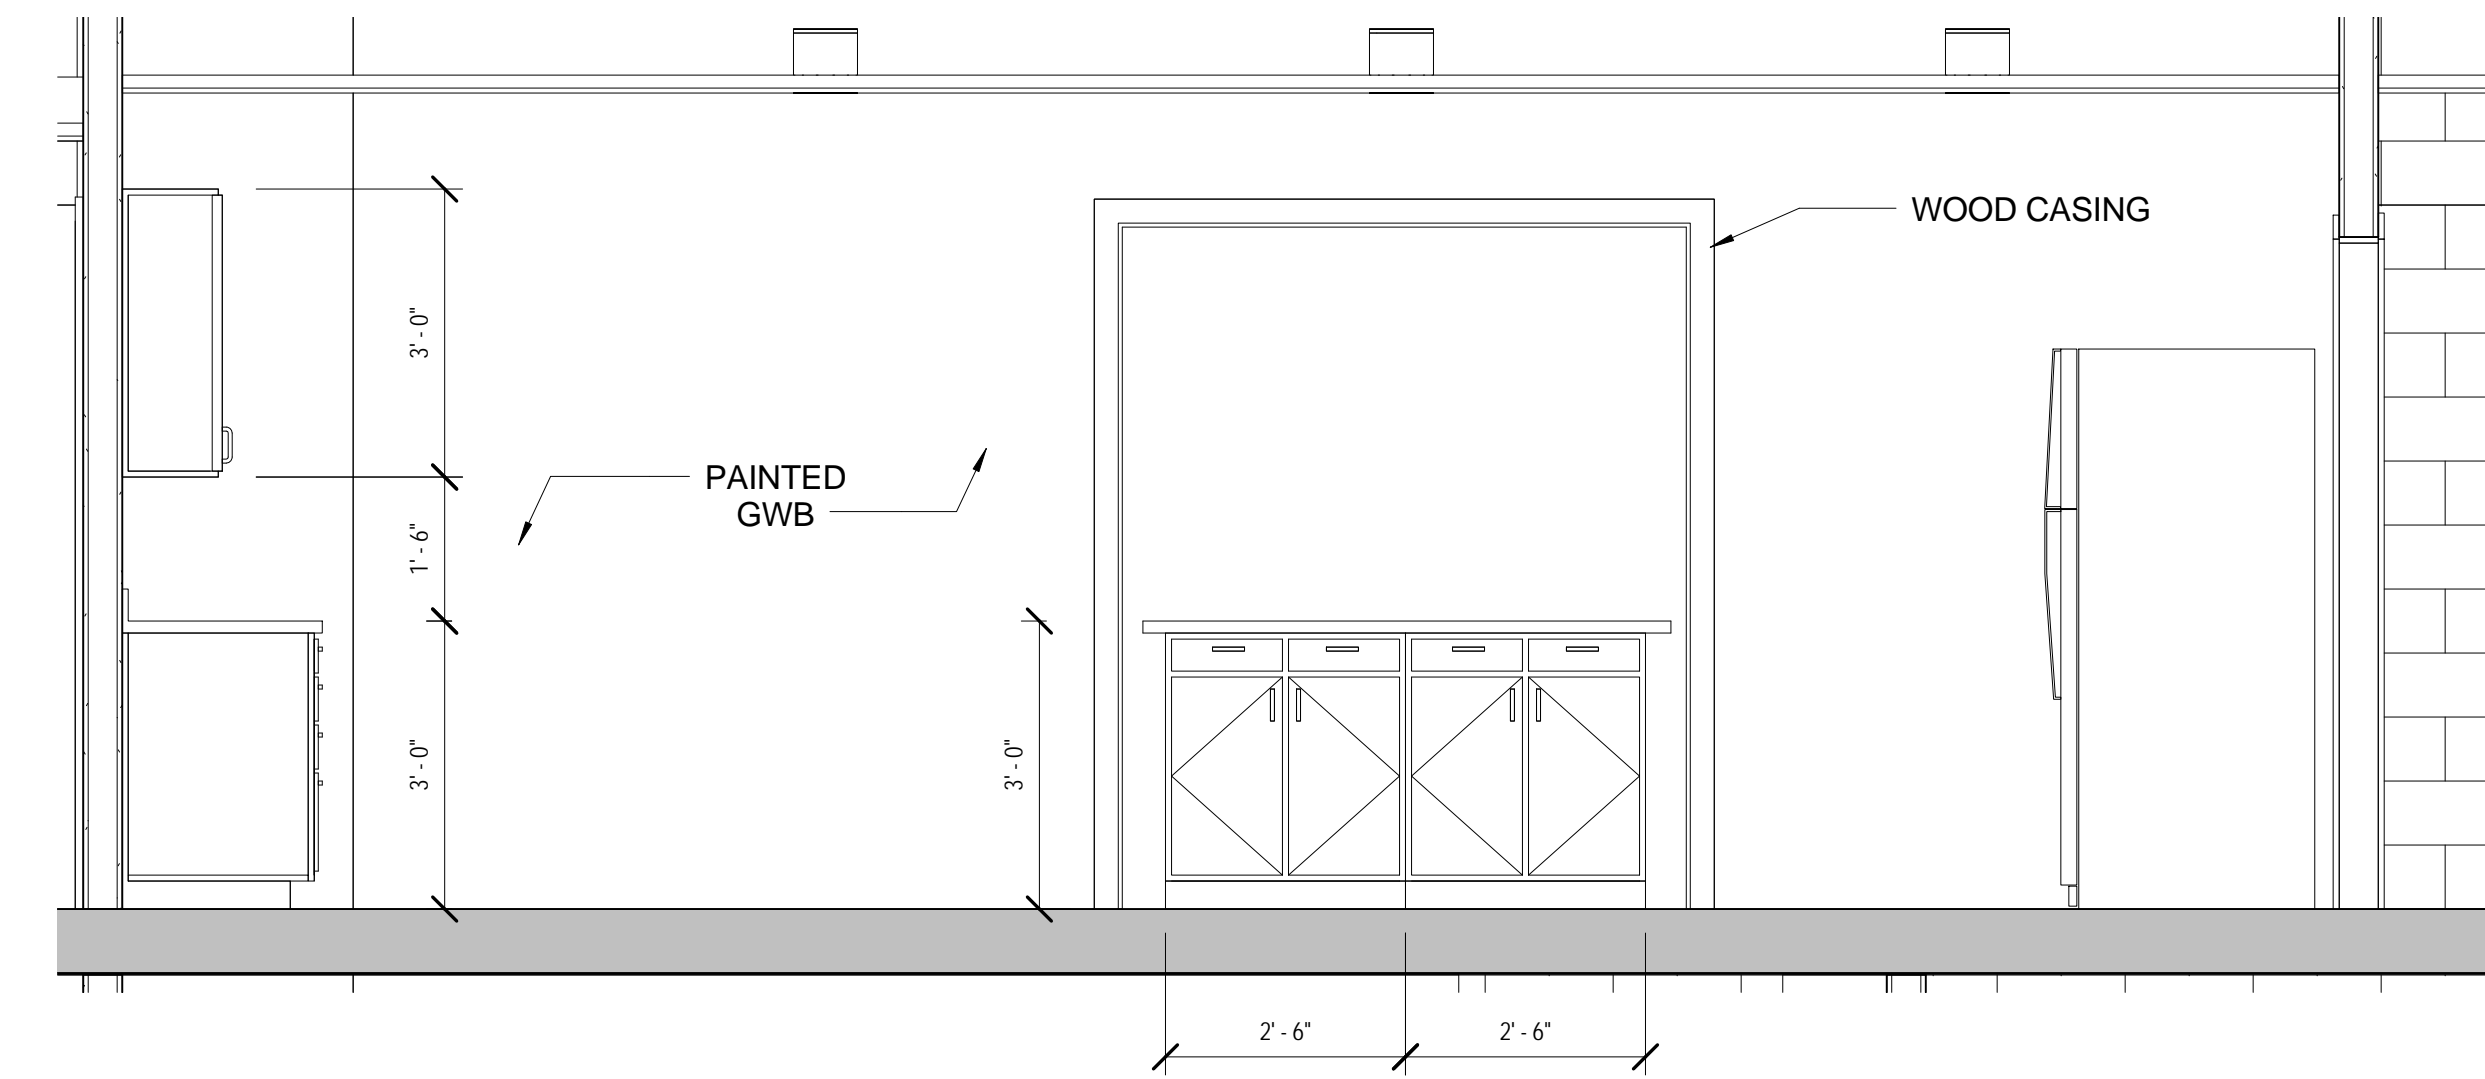


3C KITCHEN ELEVATION-2
1/2" = 1'-0"

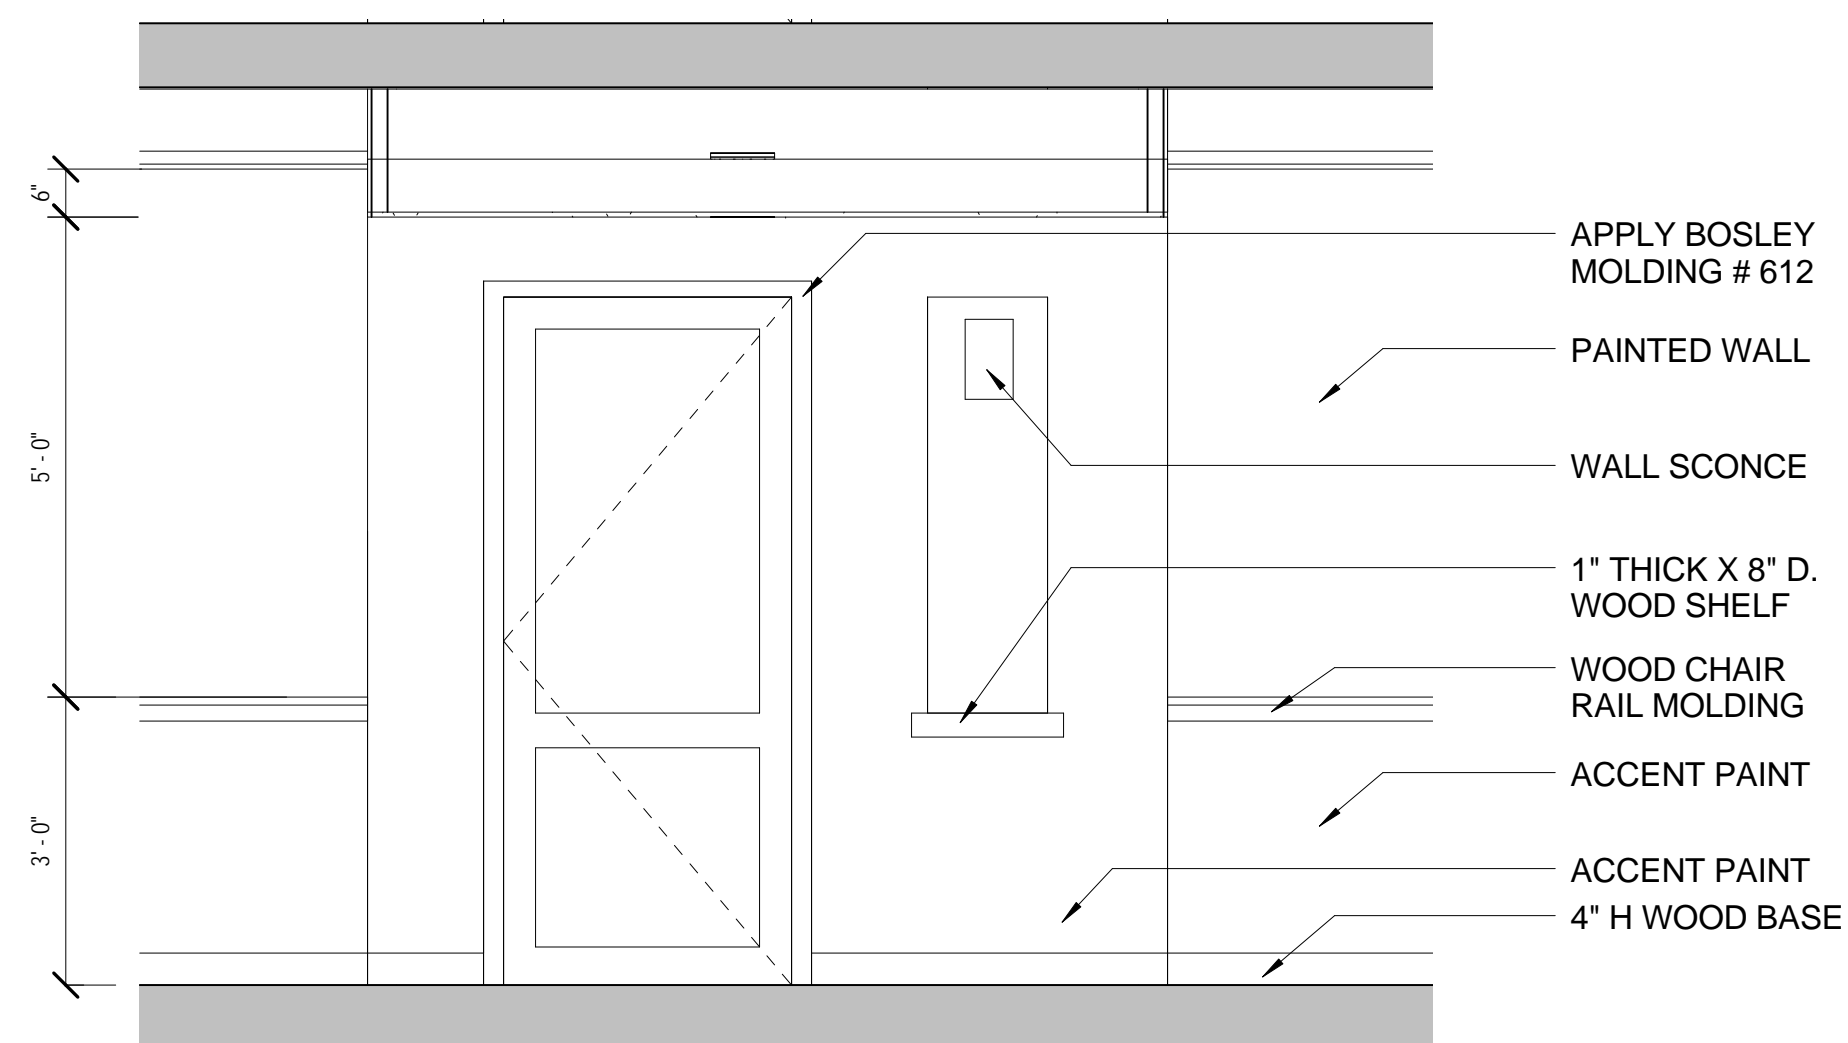


1B ELEVATION DETAIL- (TYPICAL @ BEDROOM ENTRY DOOR)
1/2" = 1'-0"

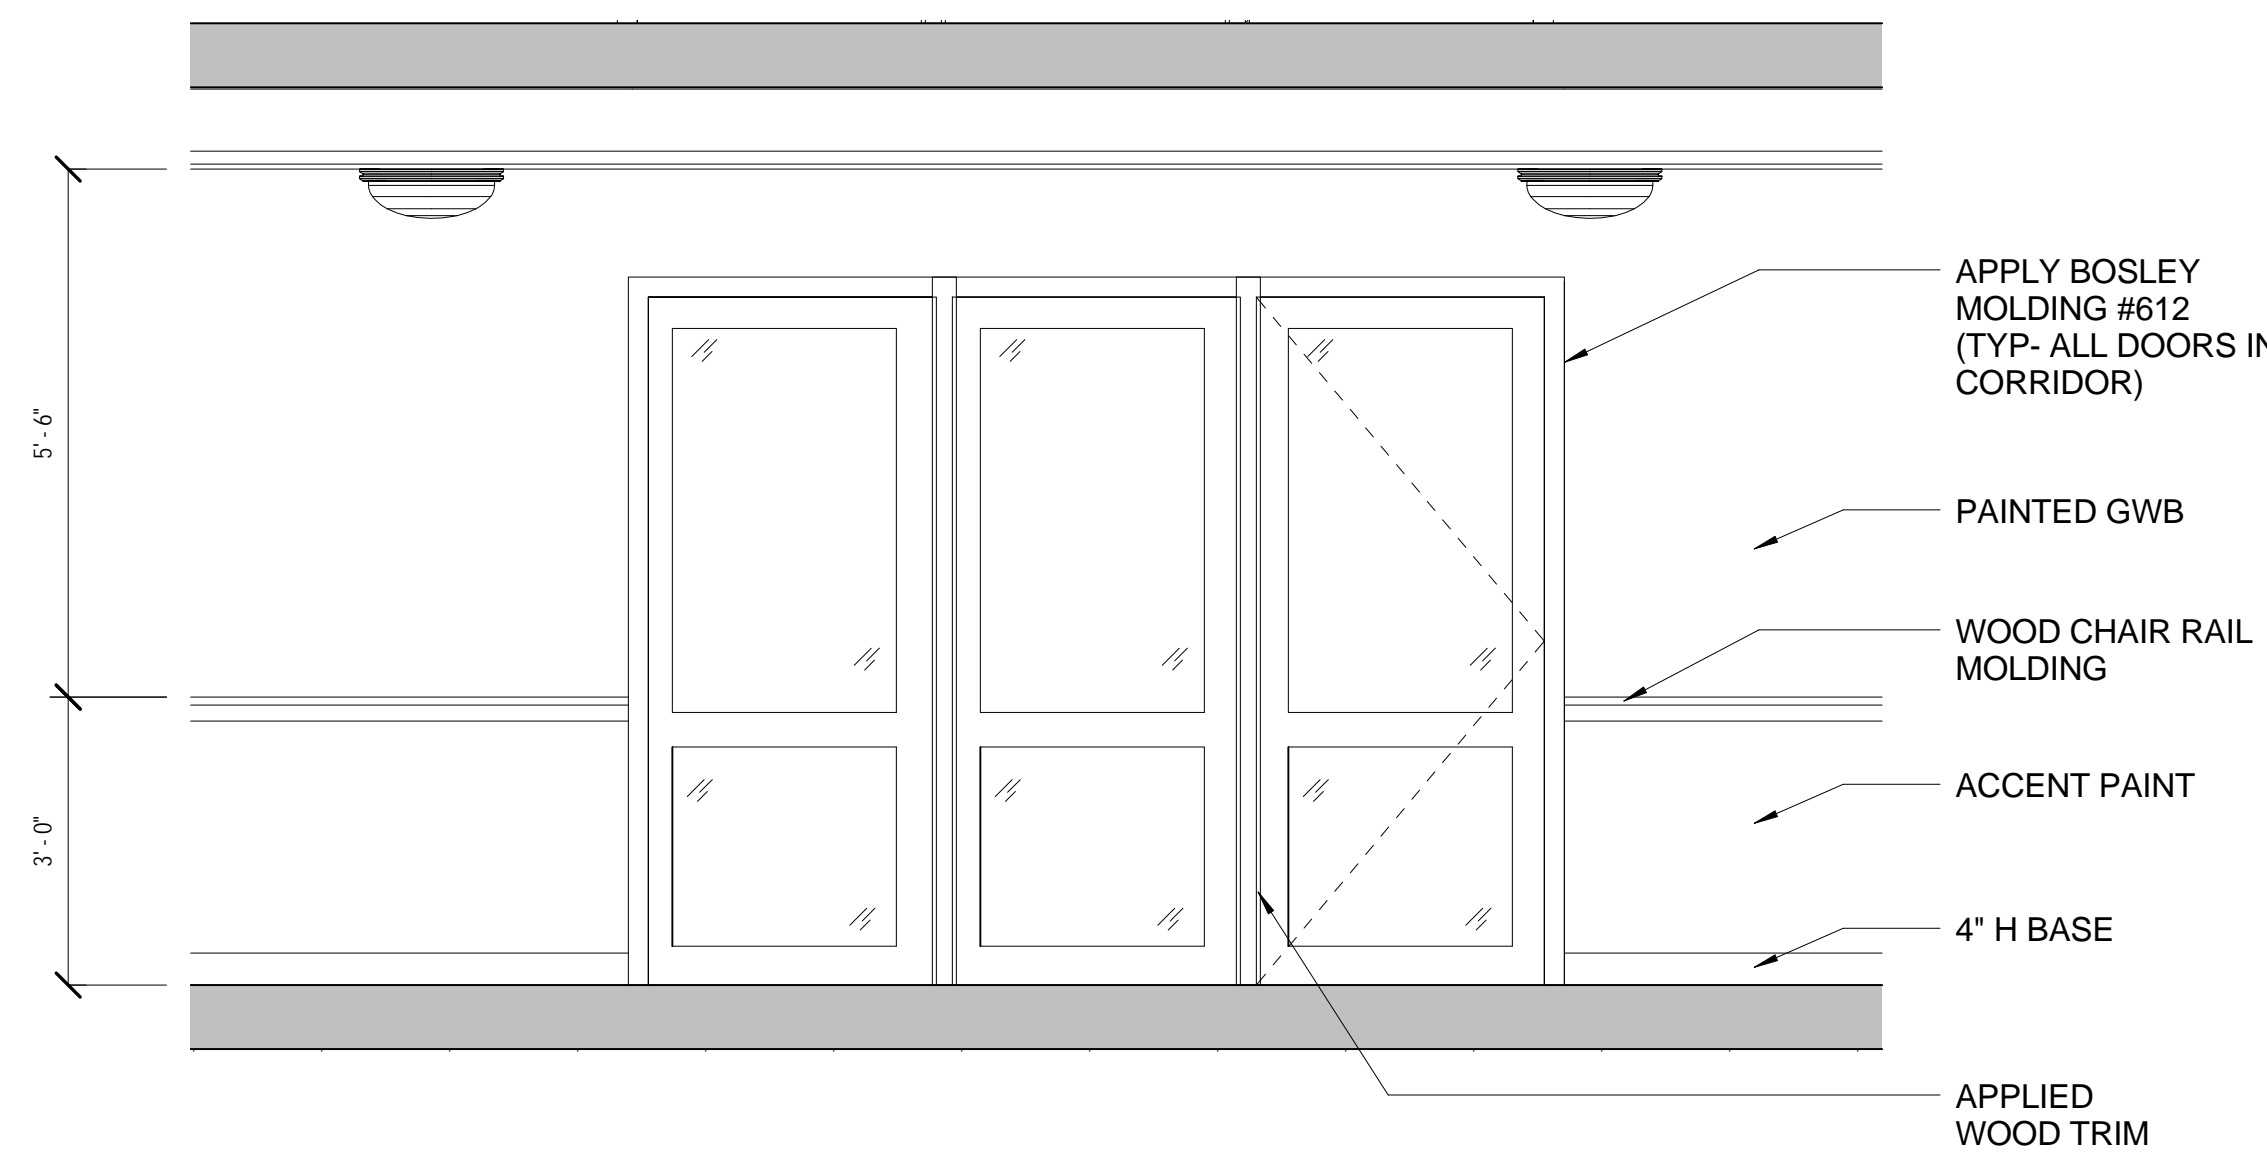


3B INTERIOR ELEVATION - LOUNGE ENTRANCE
1/2" = 1'-0"

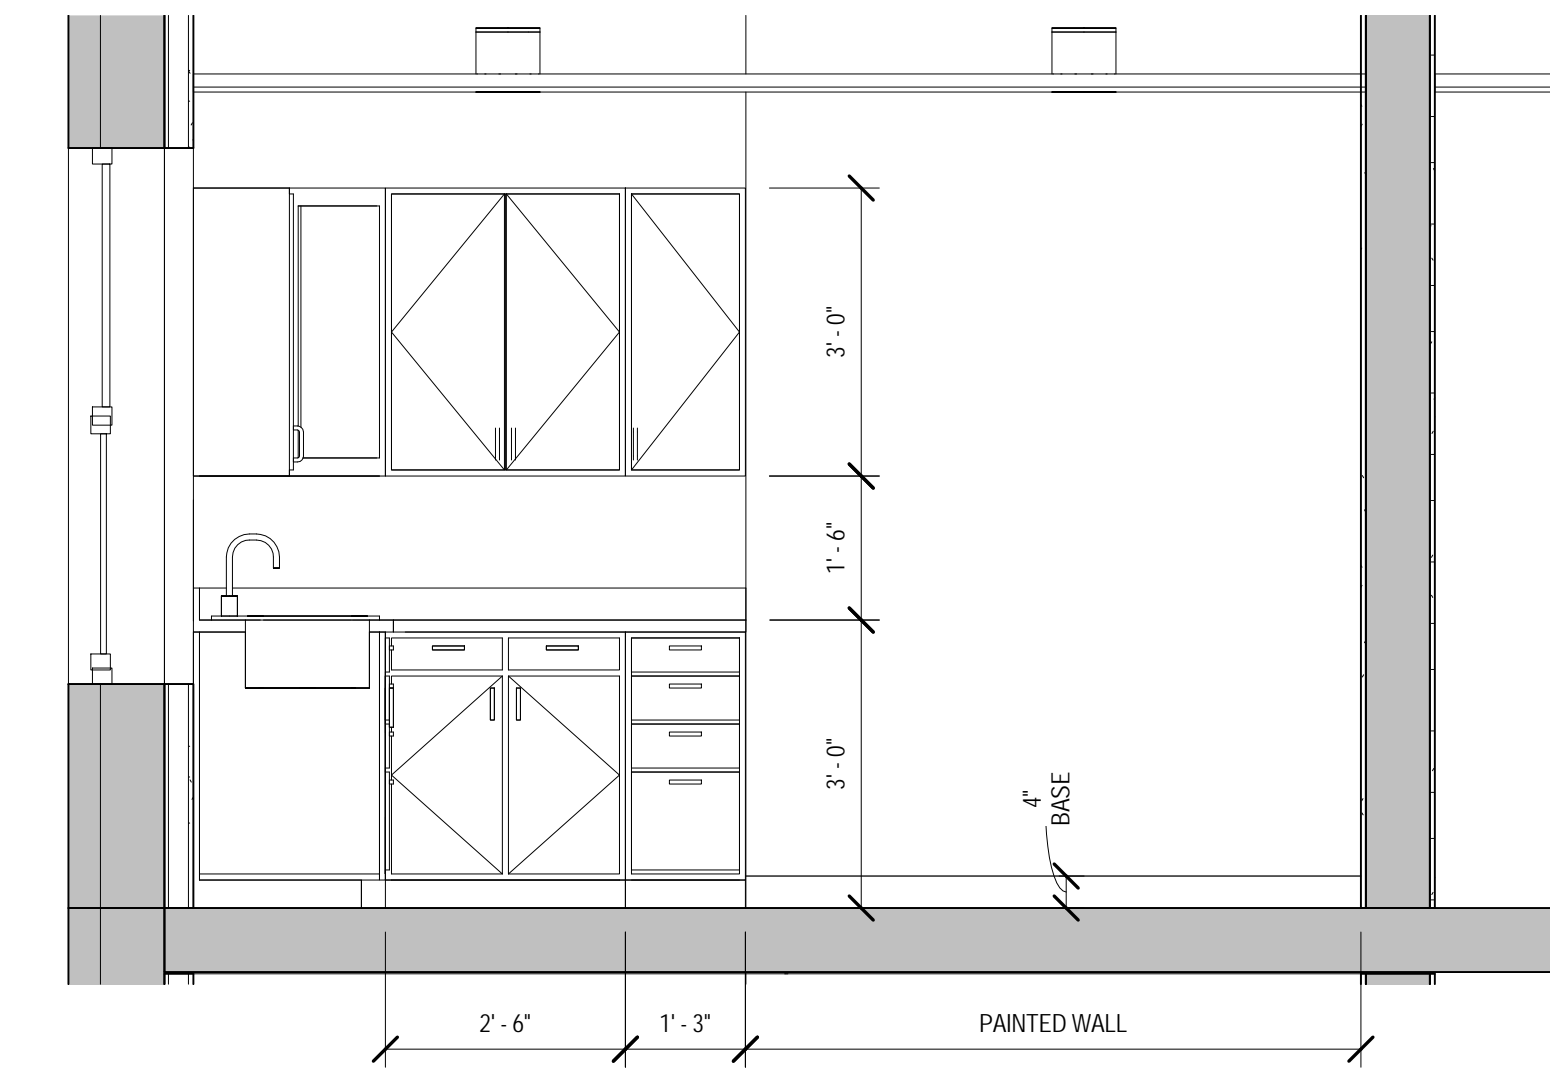










4B KITCHEN ELEVATION-3
1/2" = 1'-0"

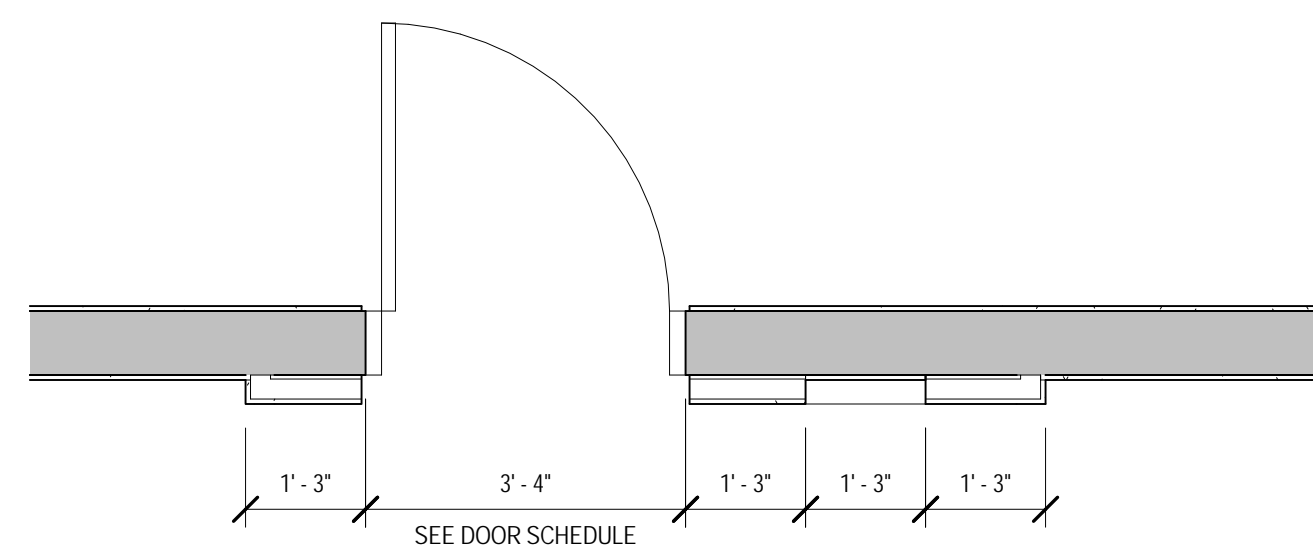

1A PLAN DETAIL - (TYPICAL @ BEDROOM ENTRY DOOR)
1/2" = 1'-0"

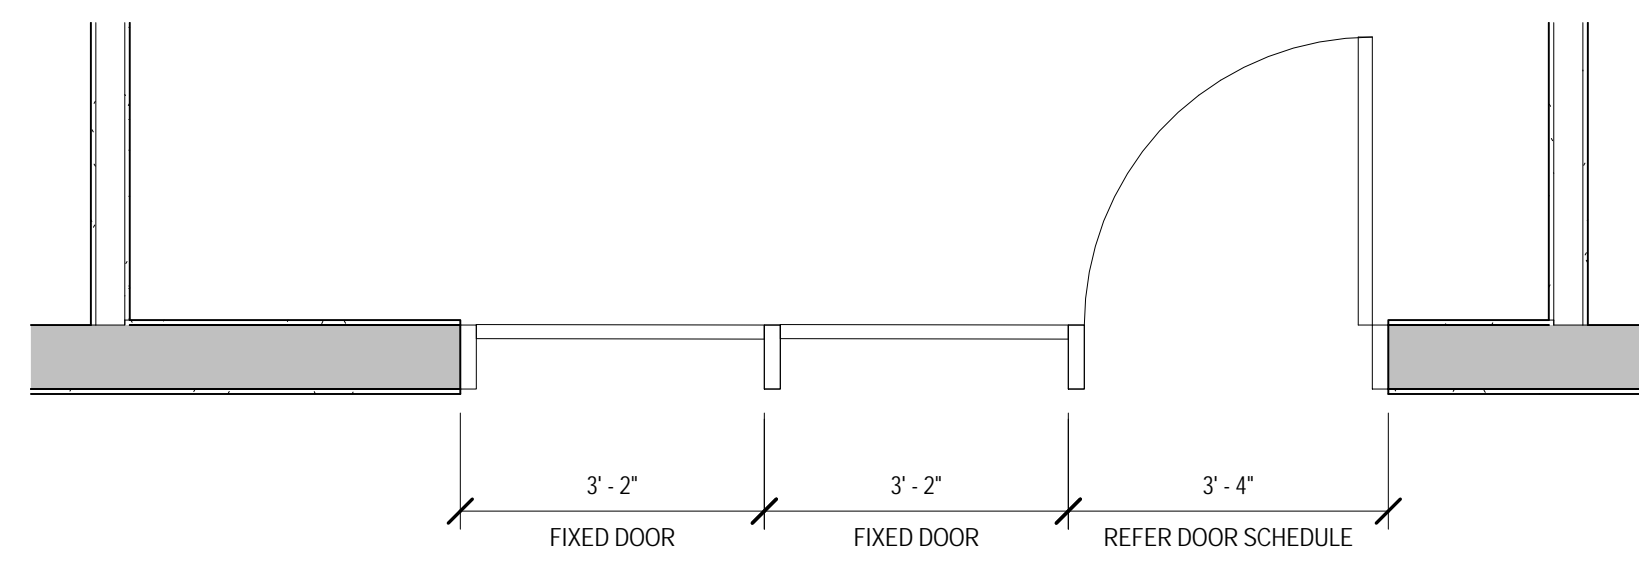

3A PLAN DETAIL- VISITOR'S LOUNGE & LIBRARY ENTRANCE
1/2" = 1'-0"

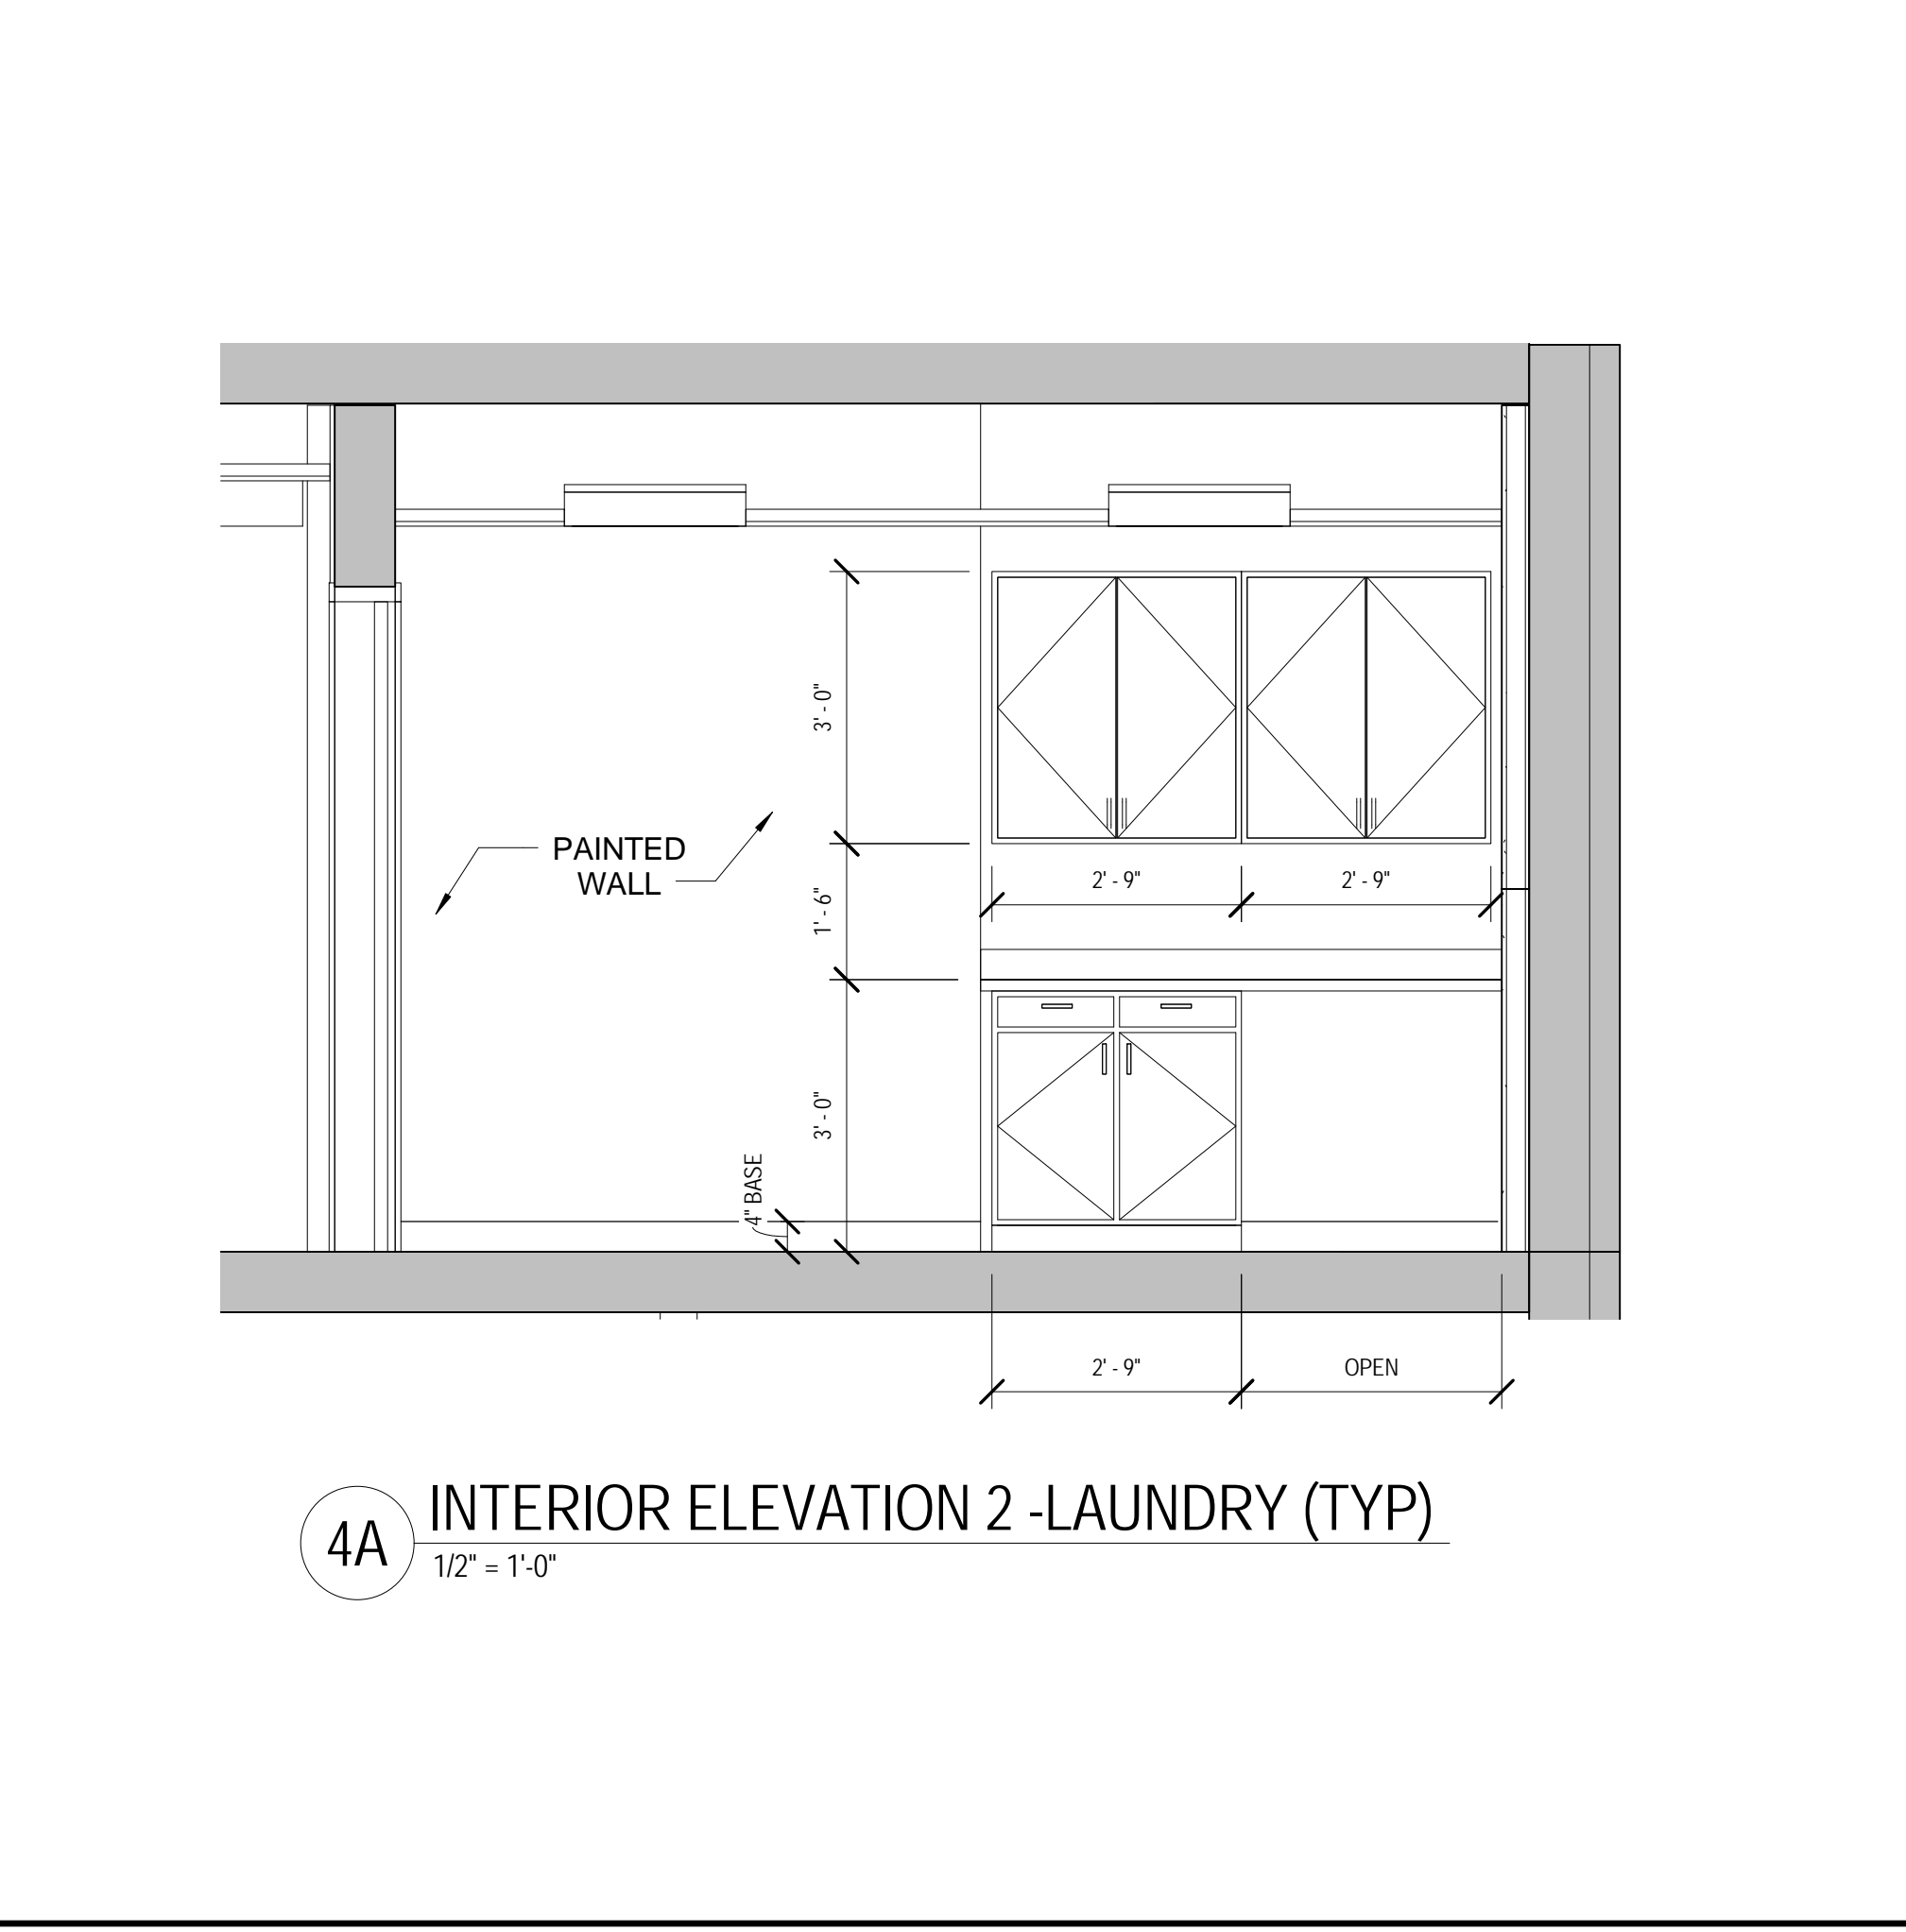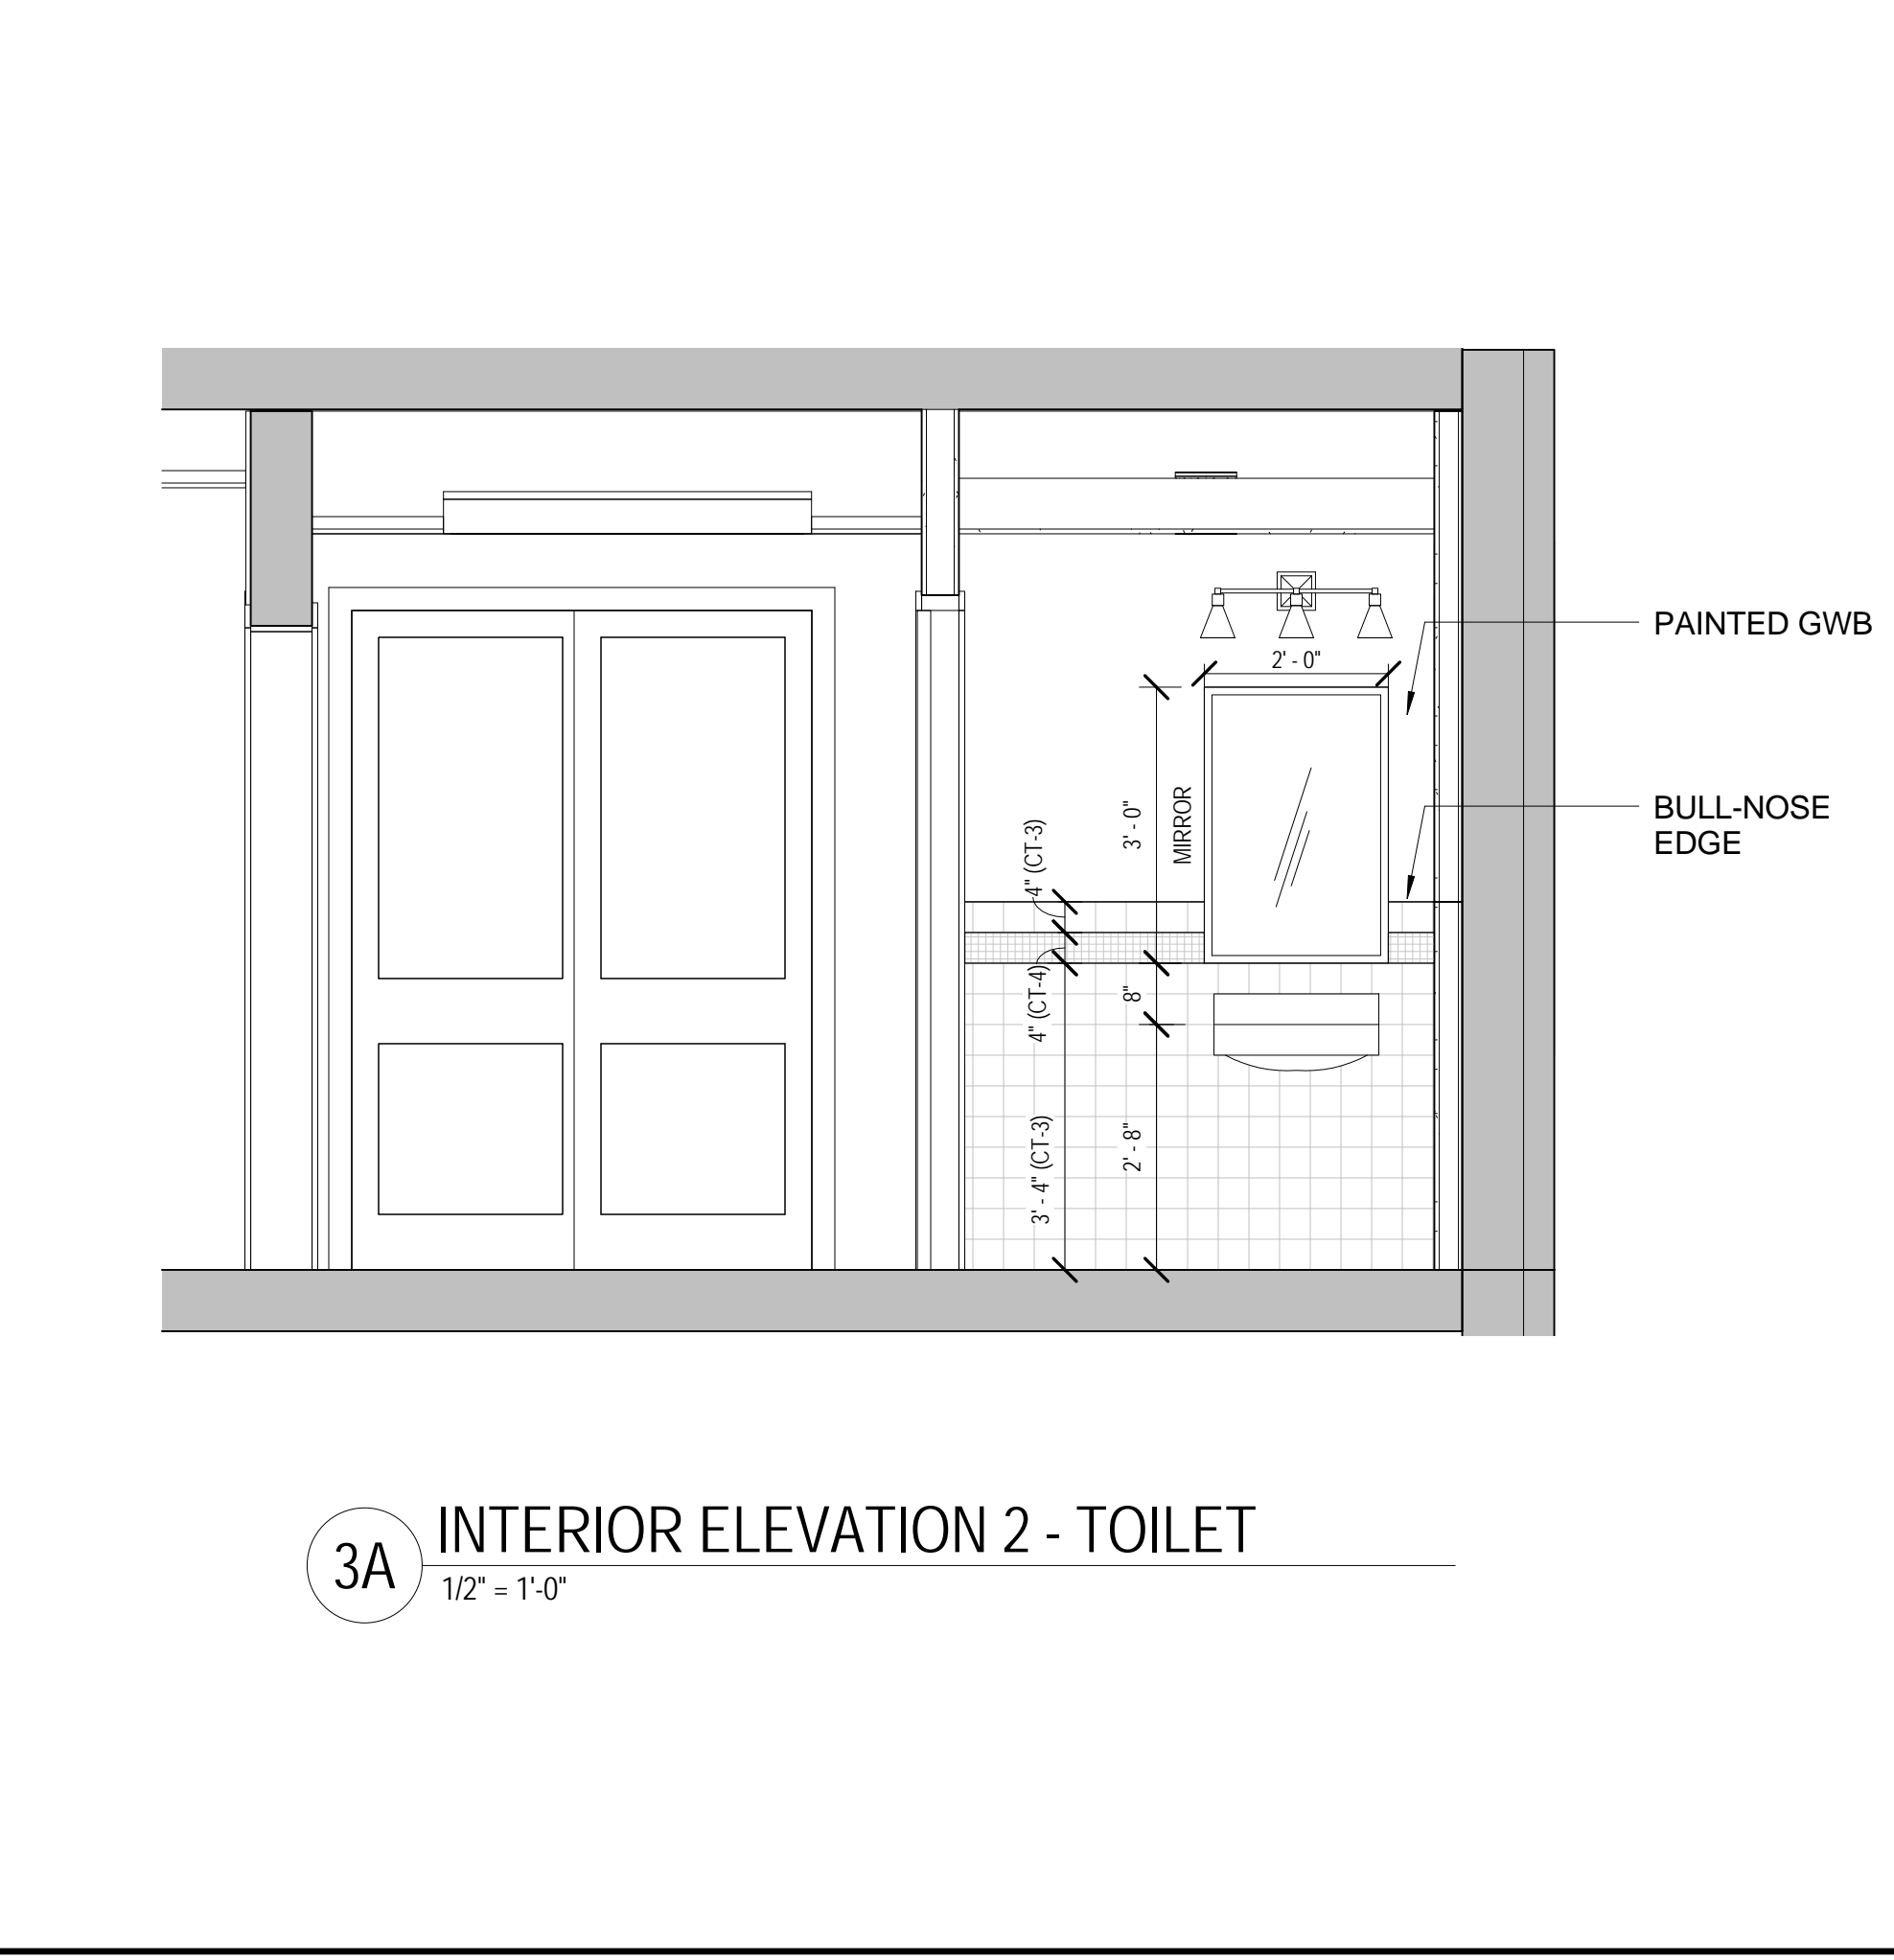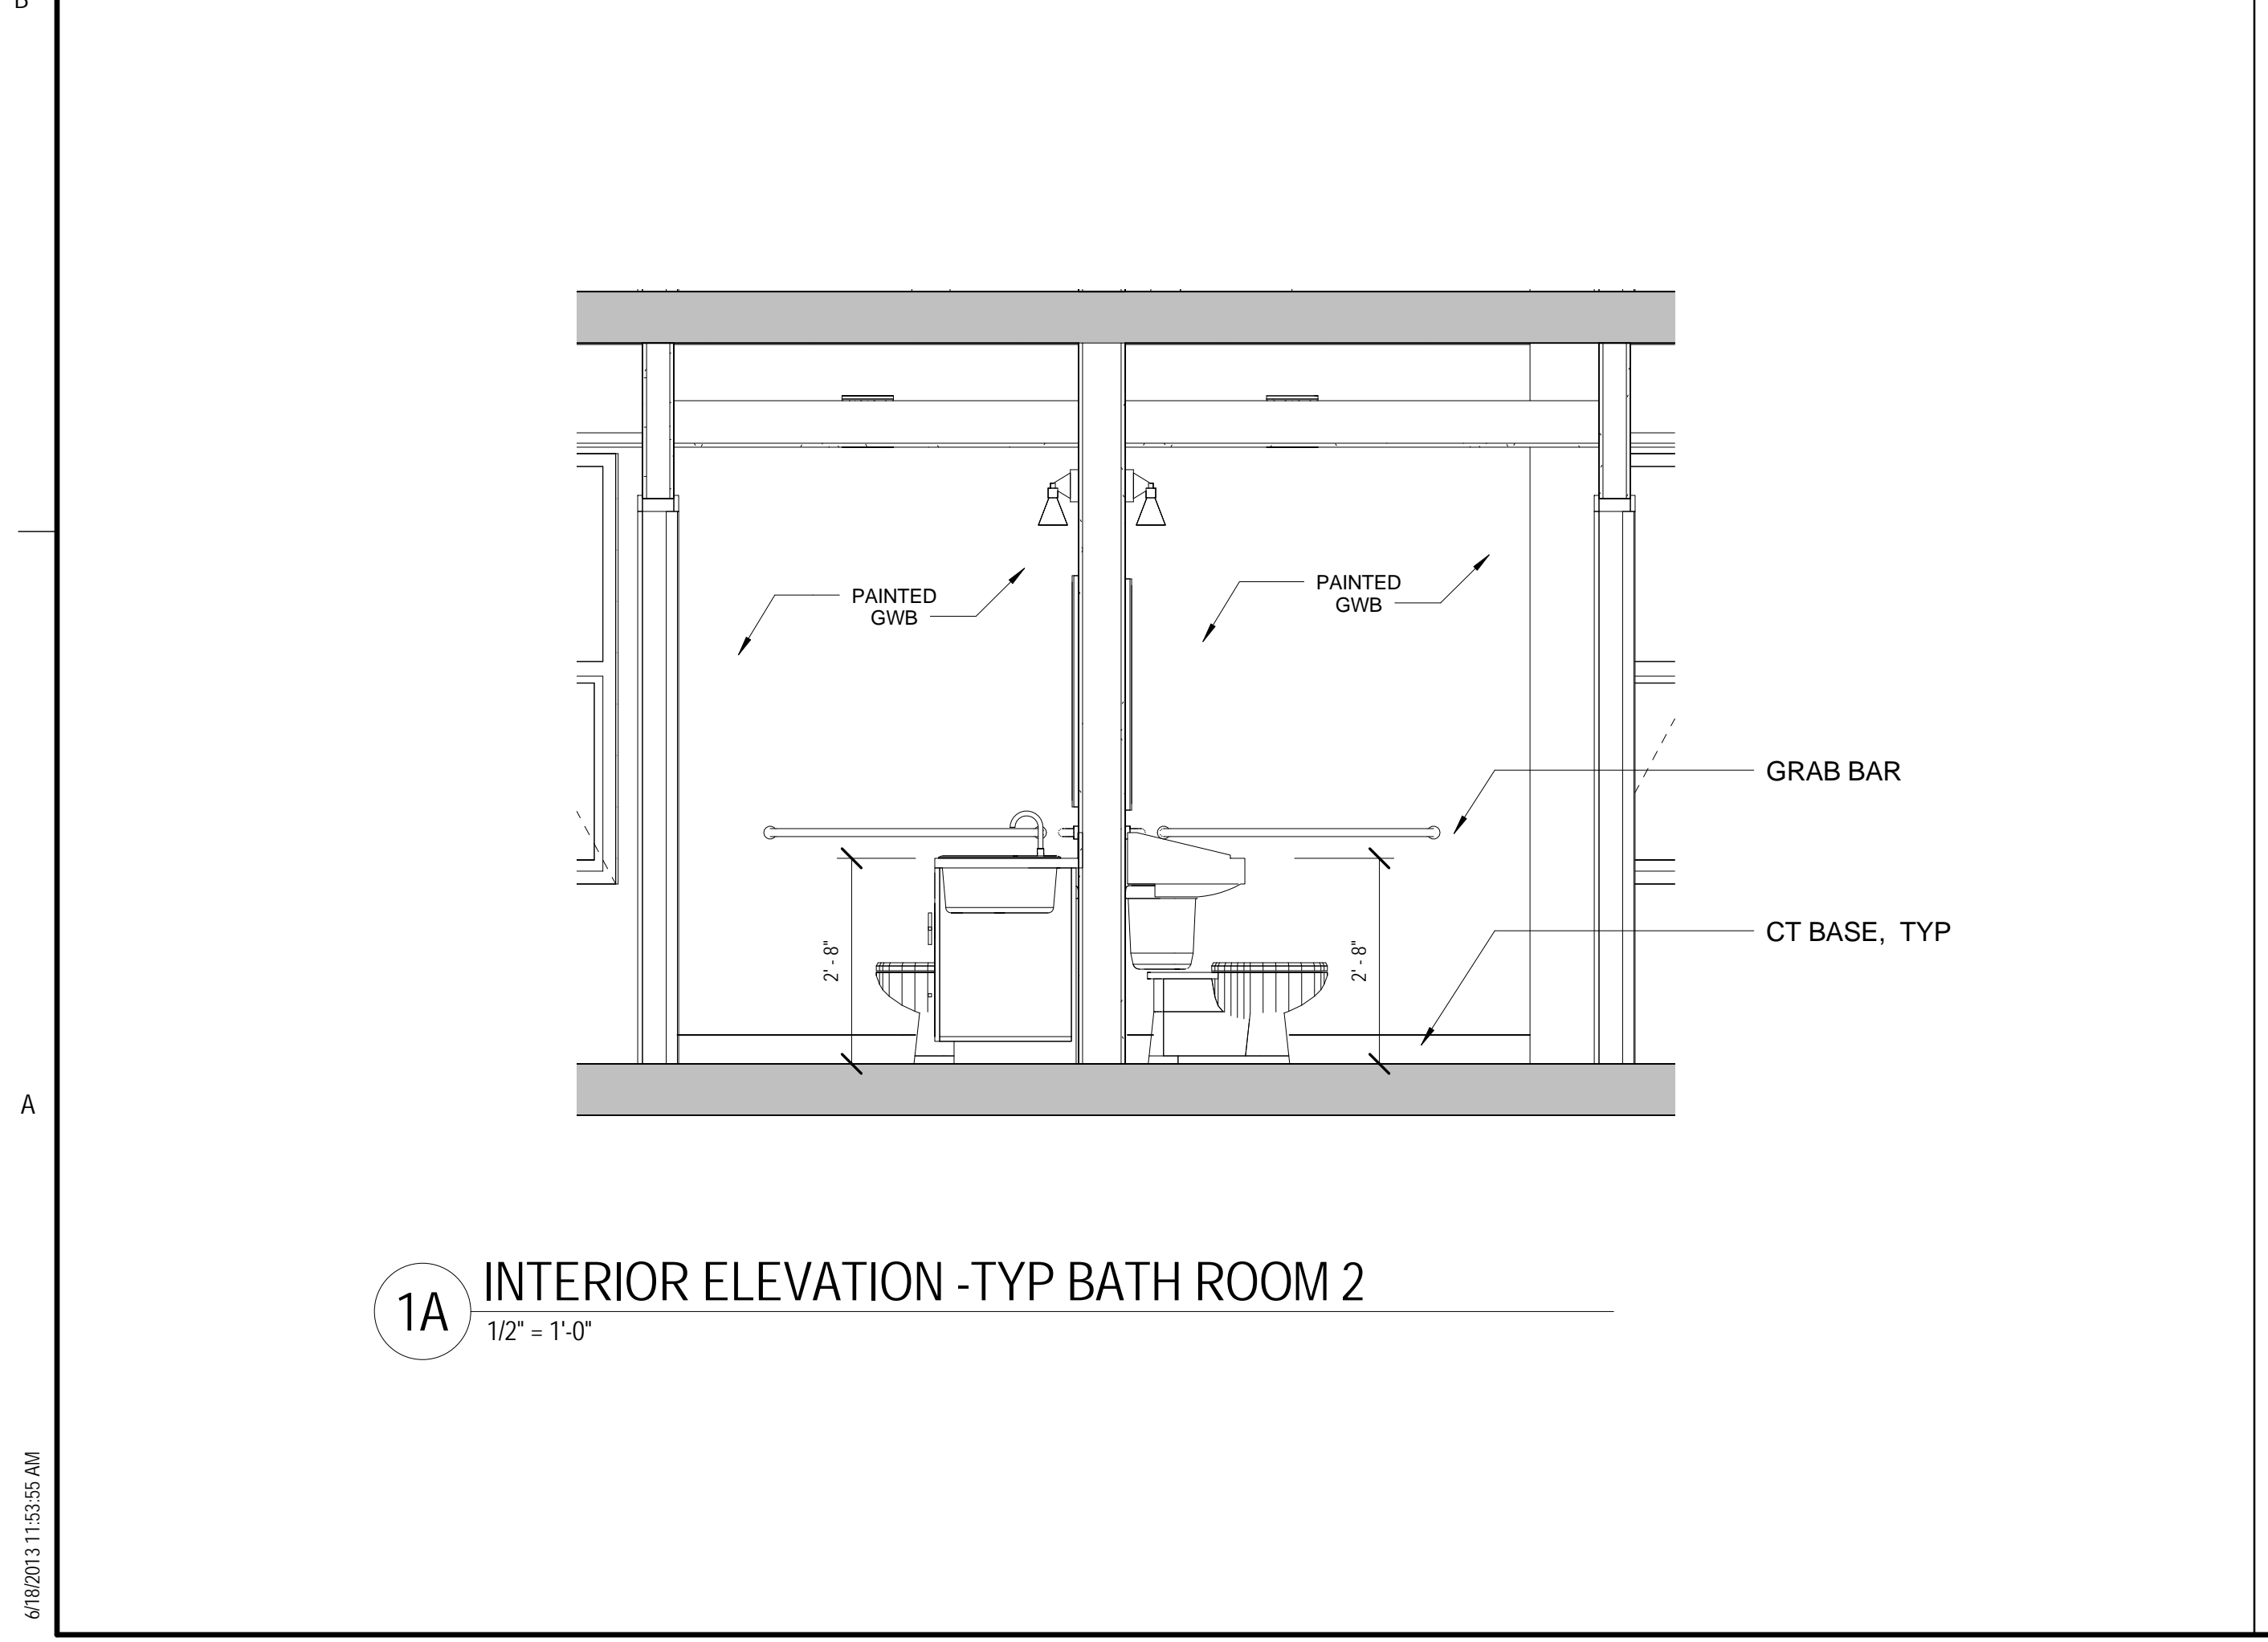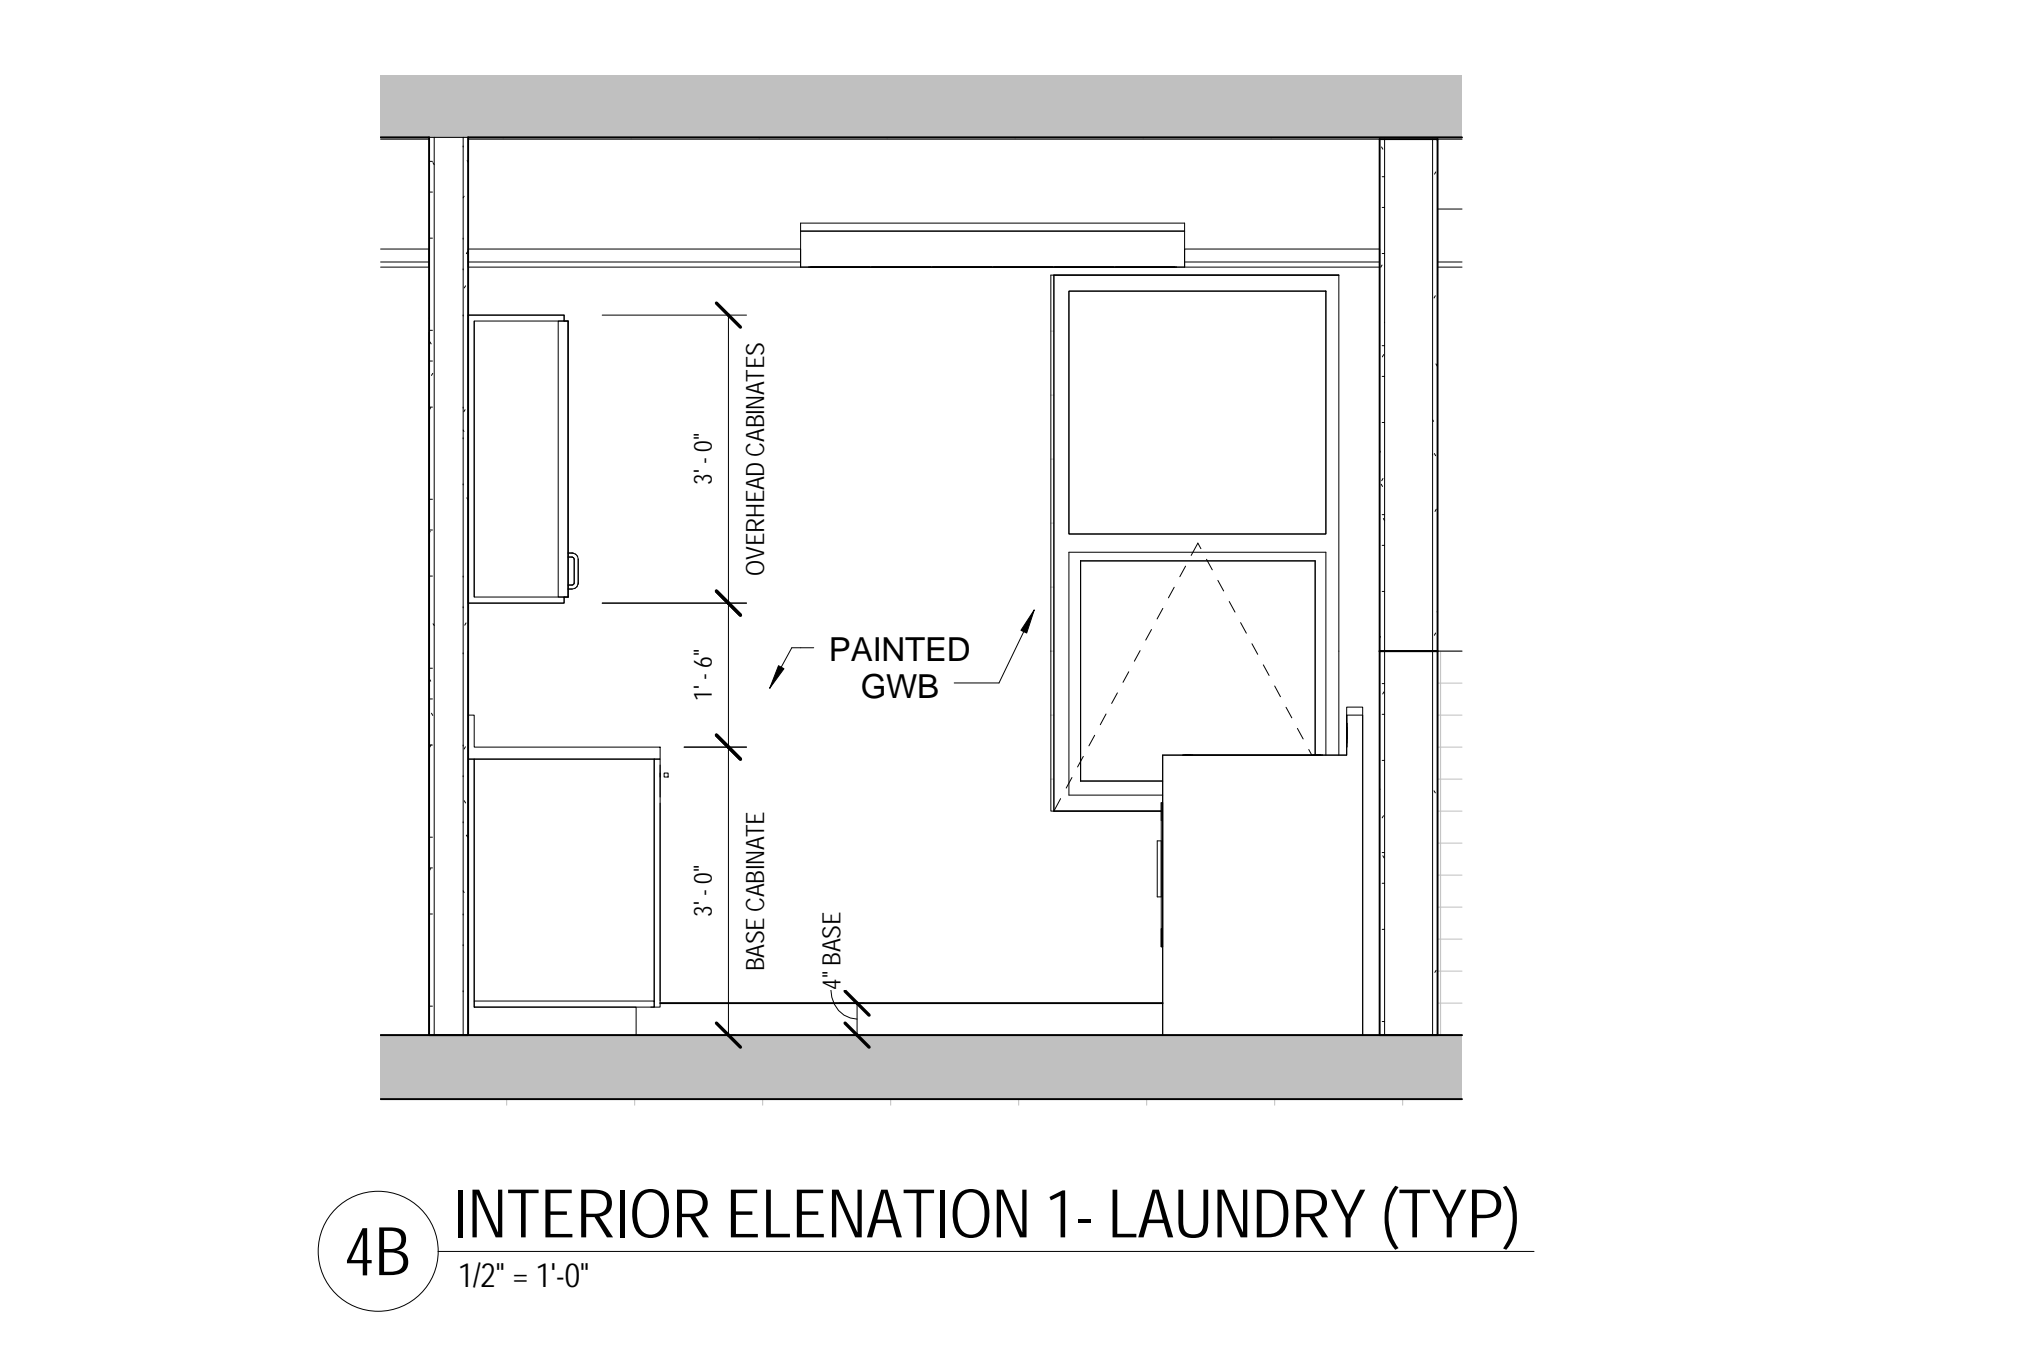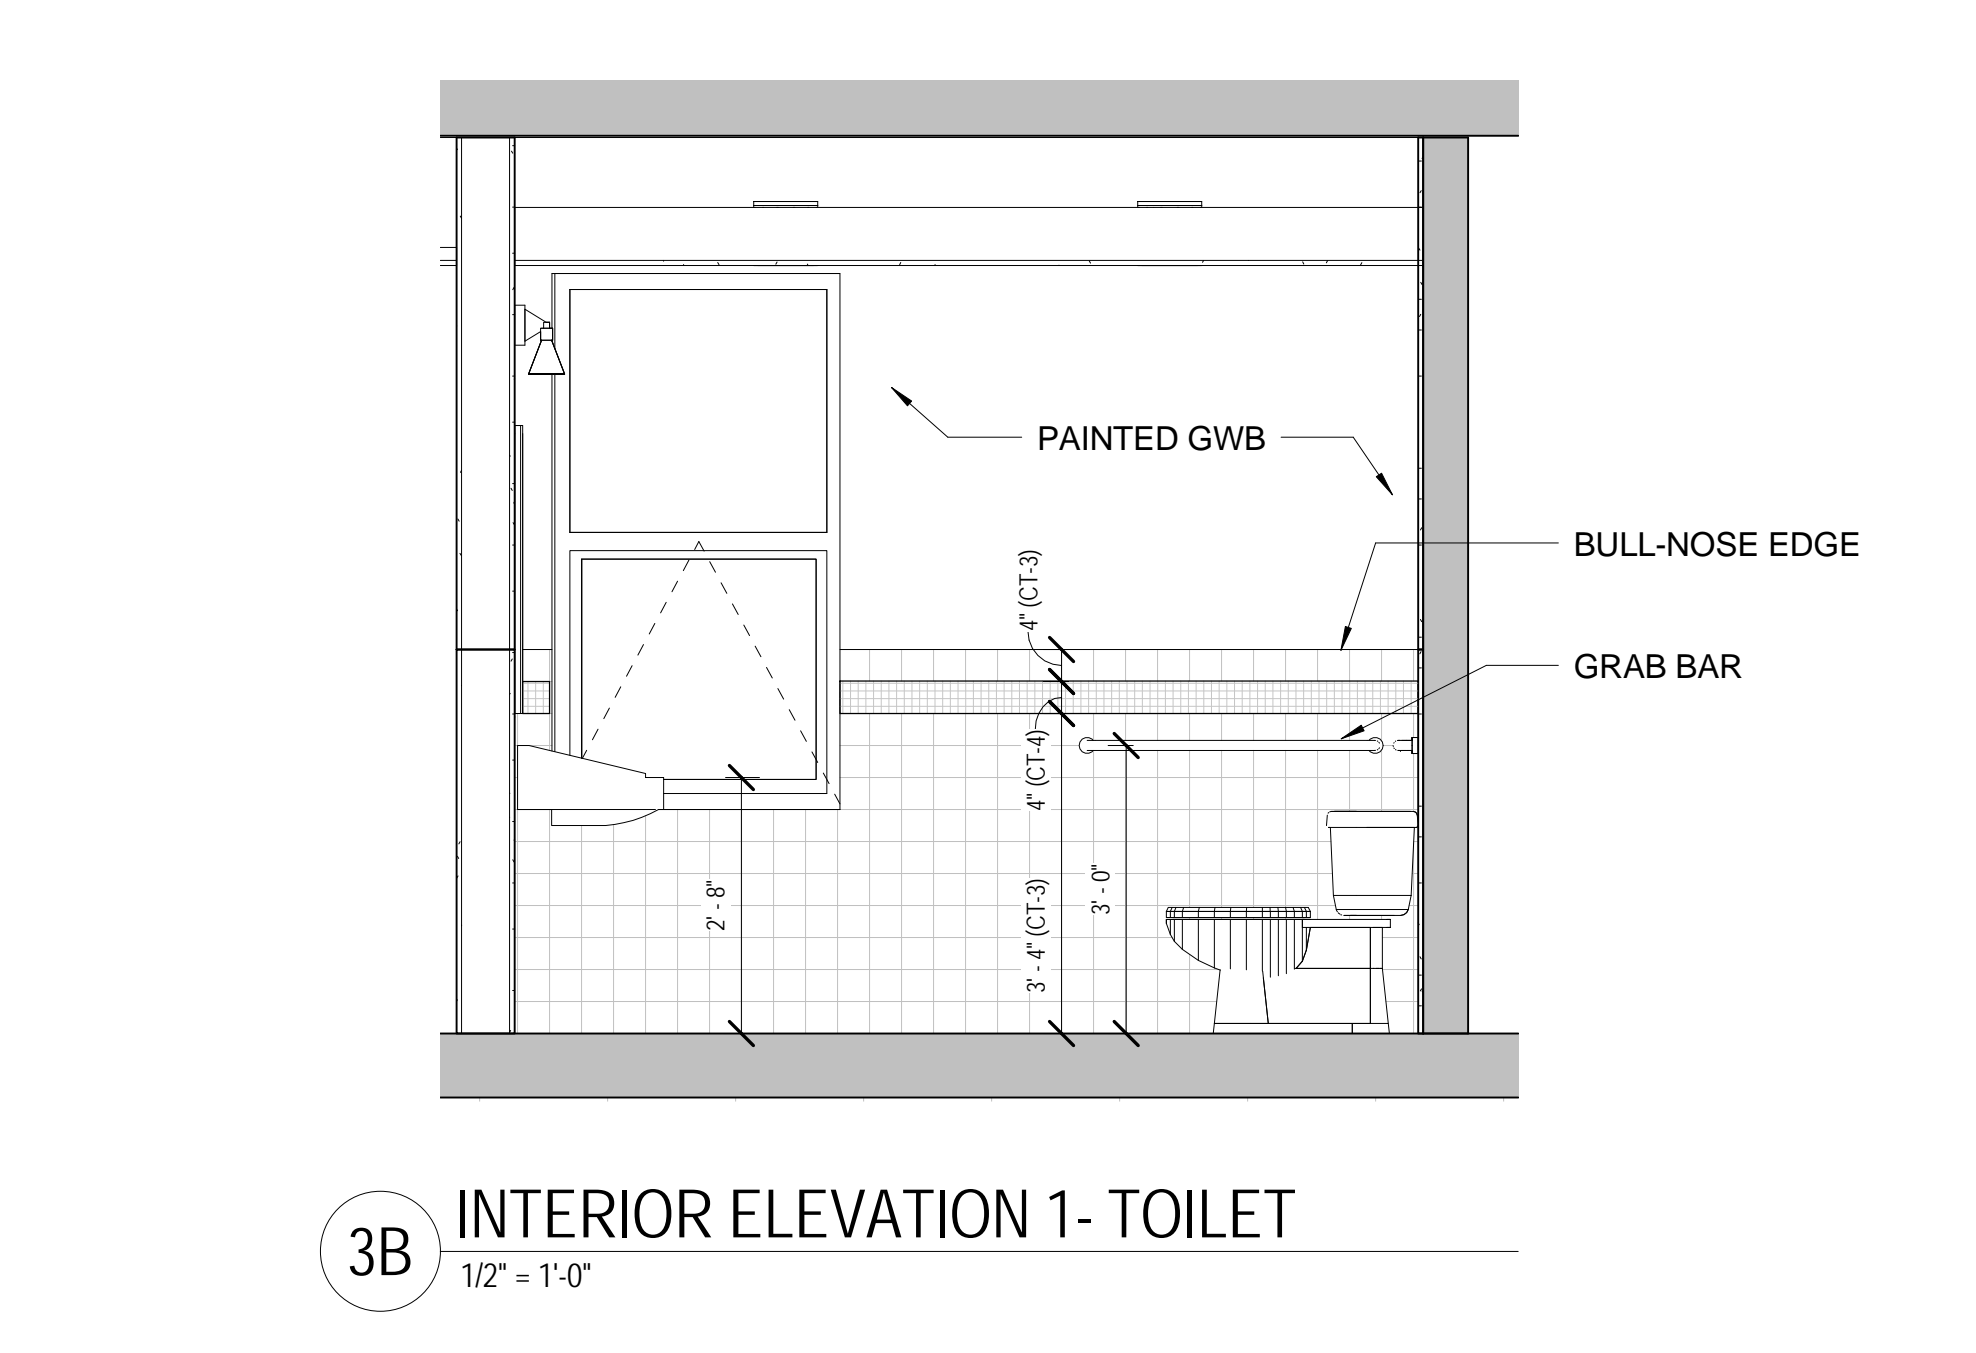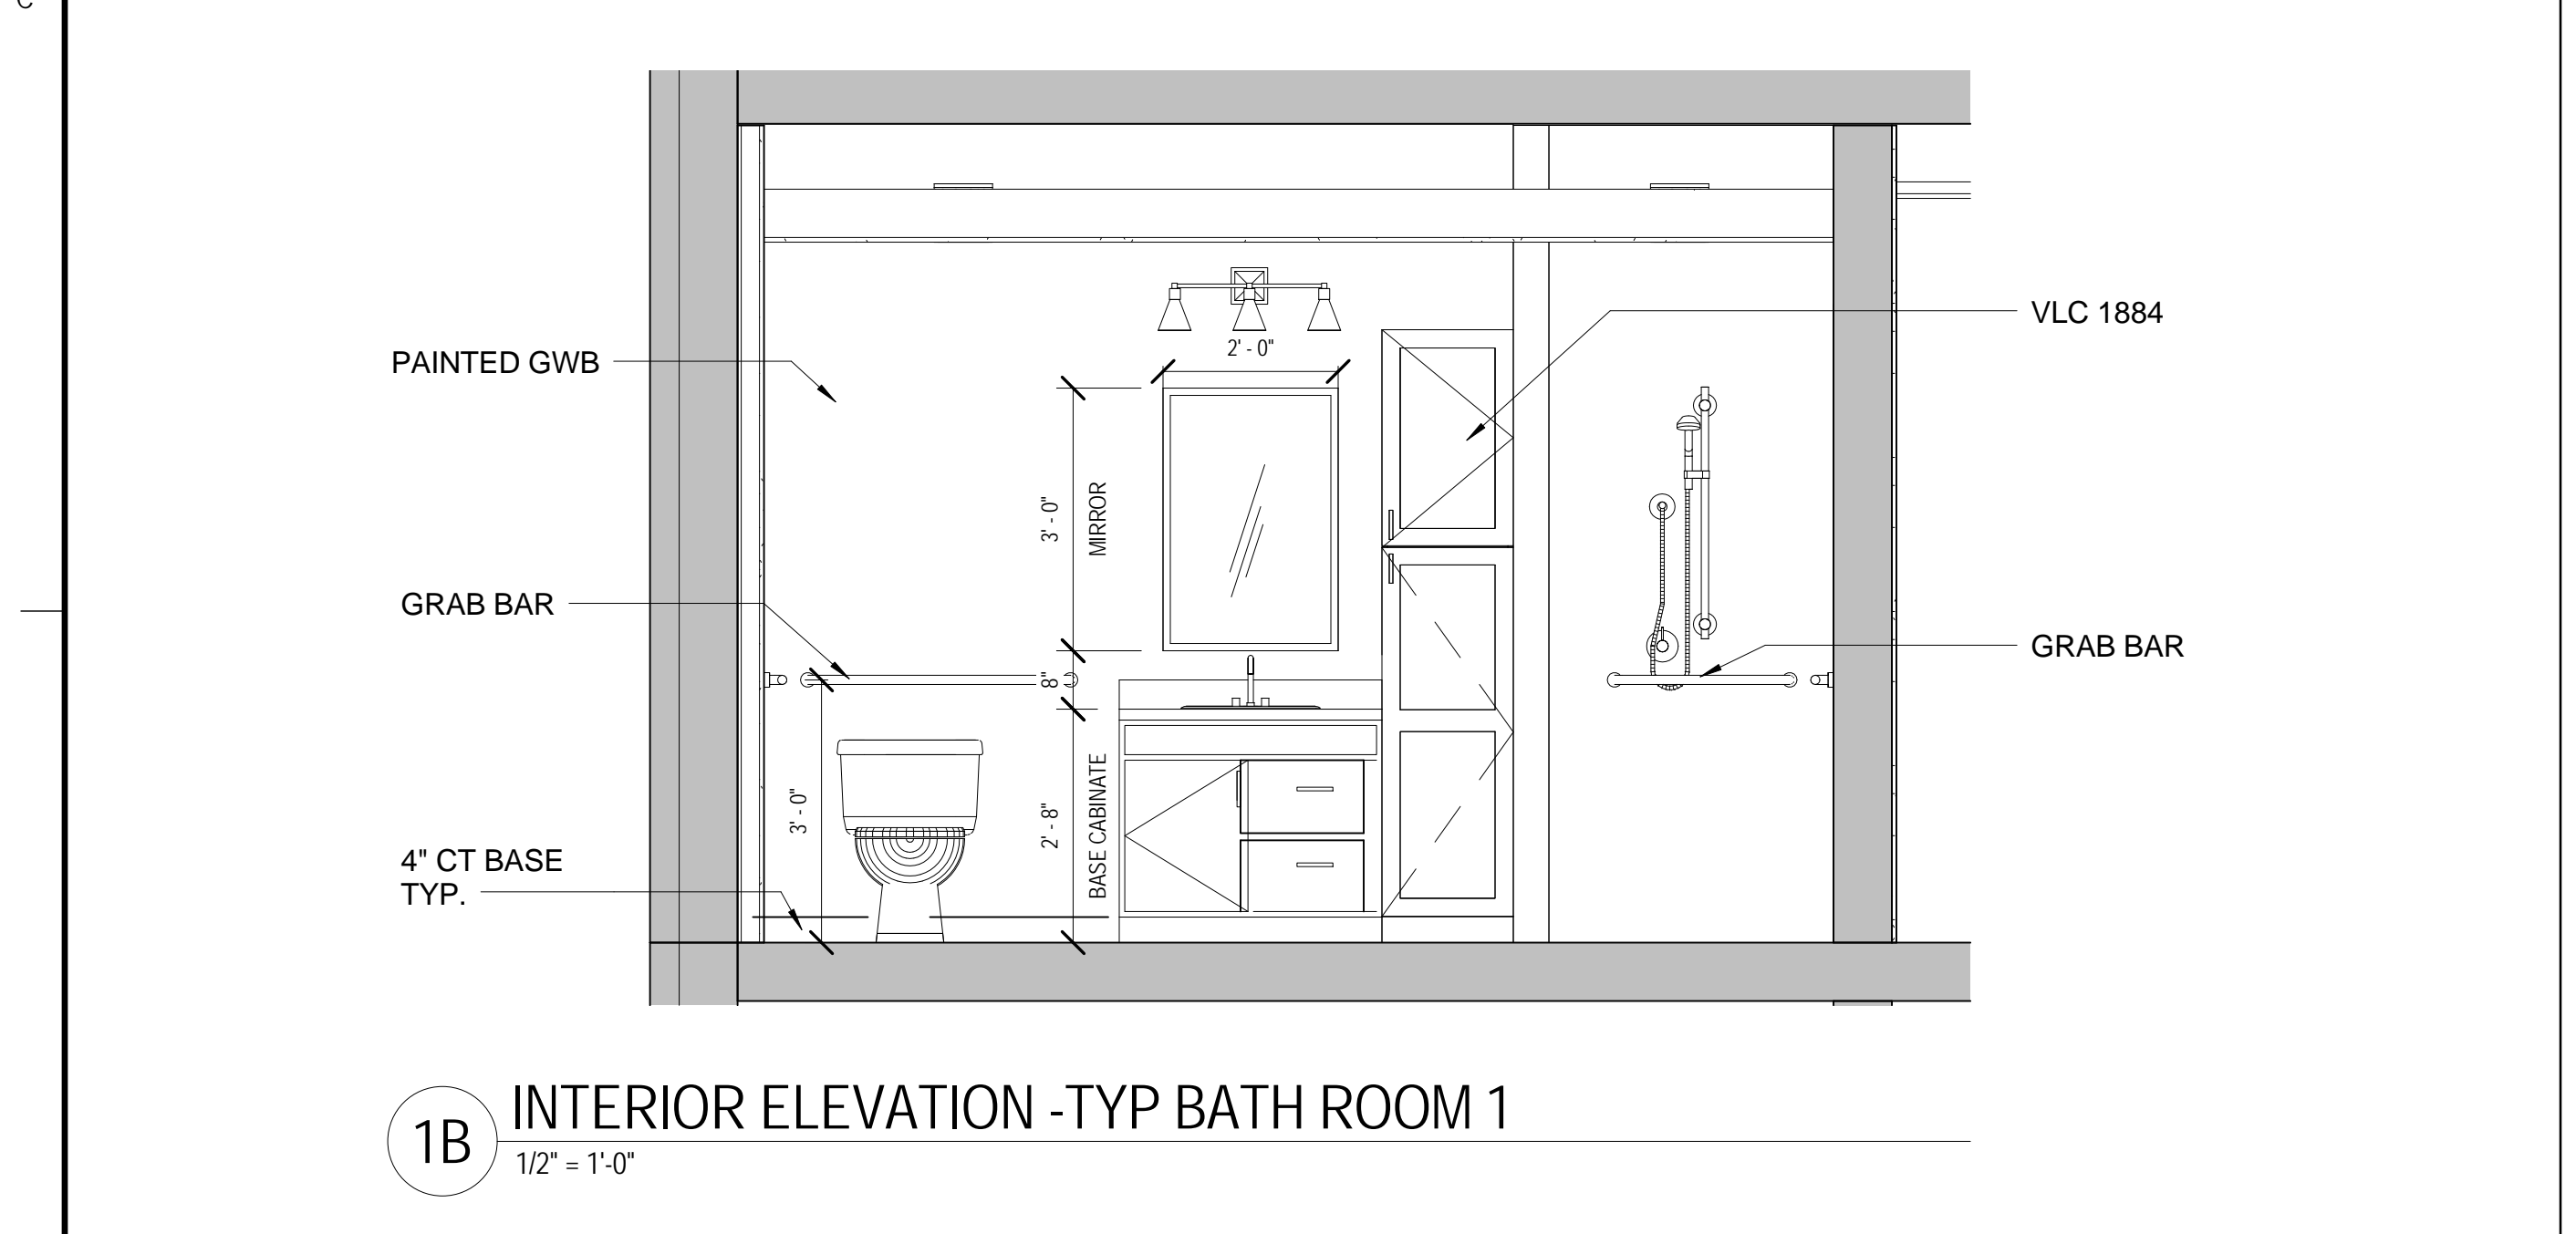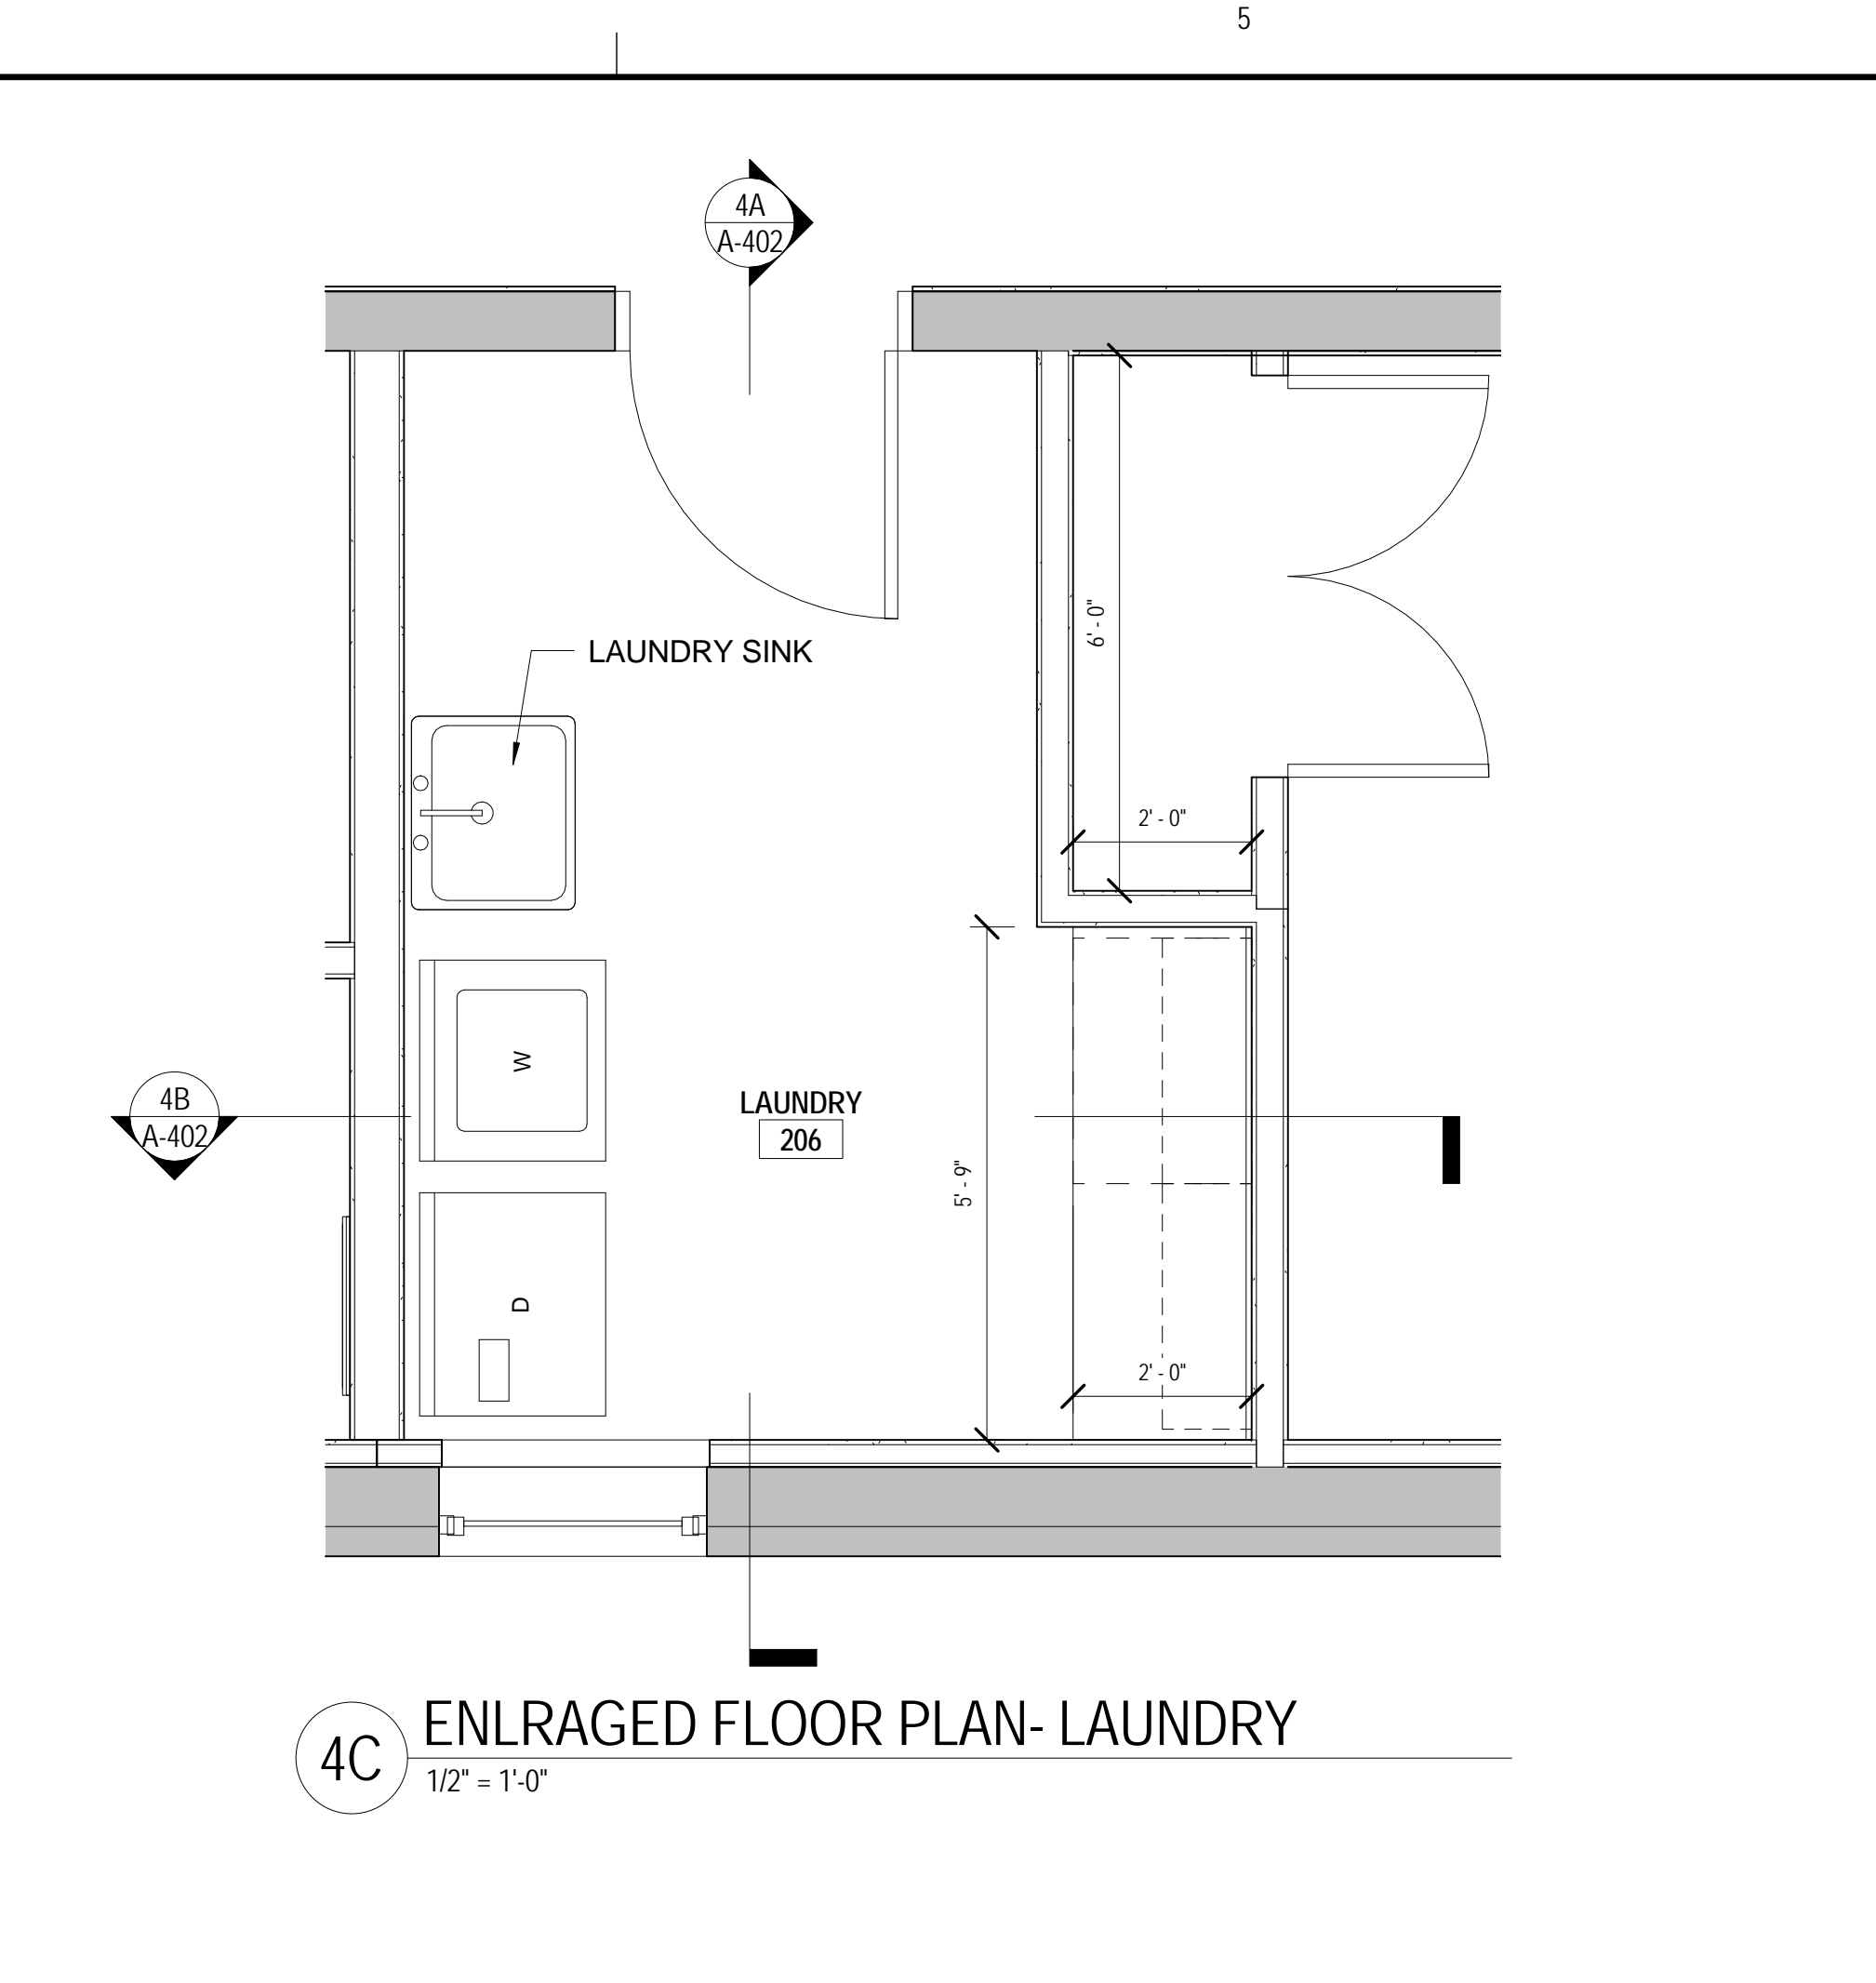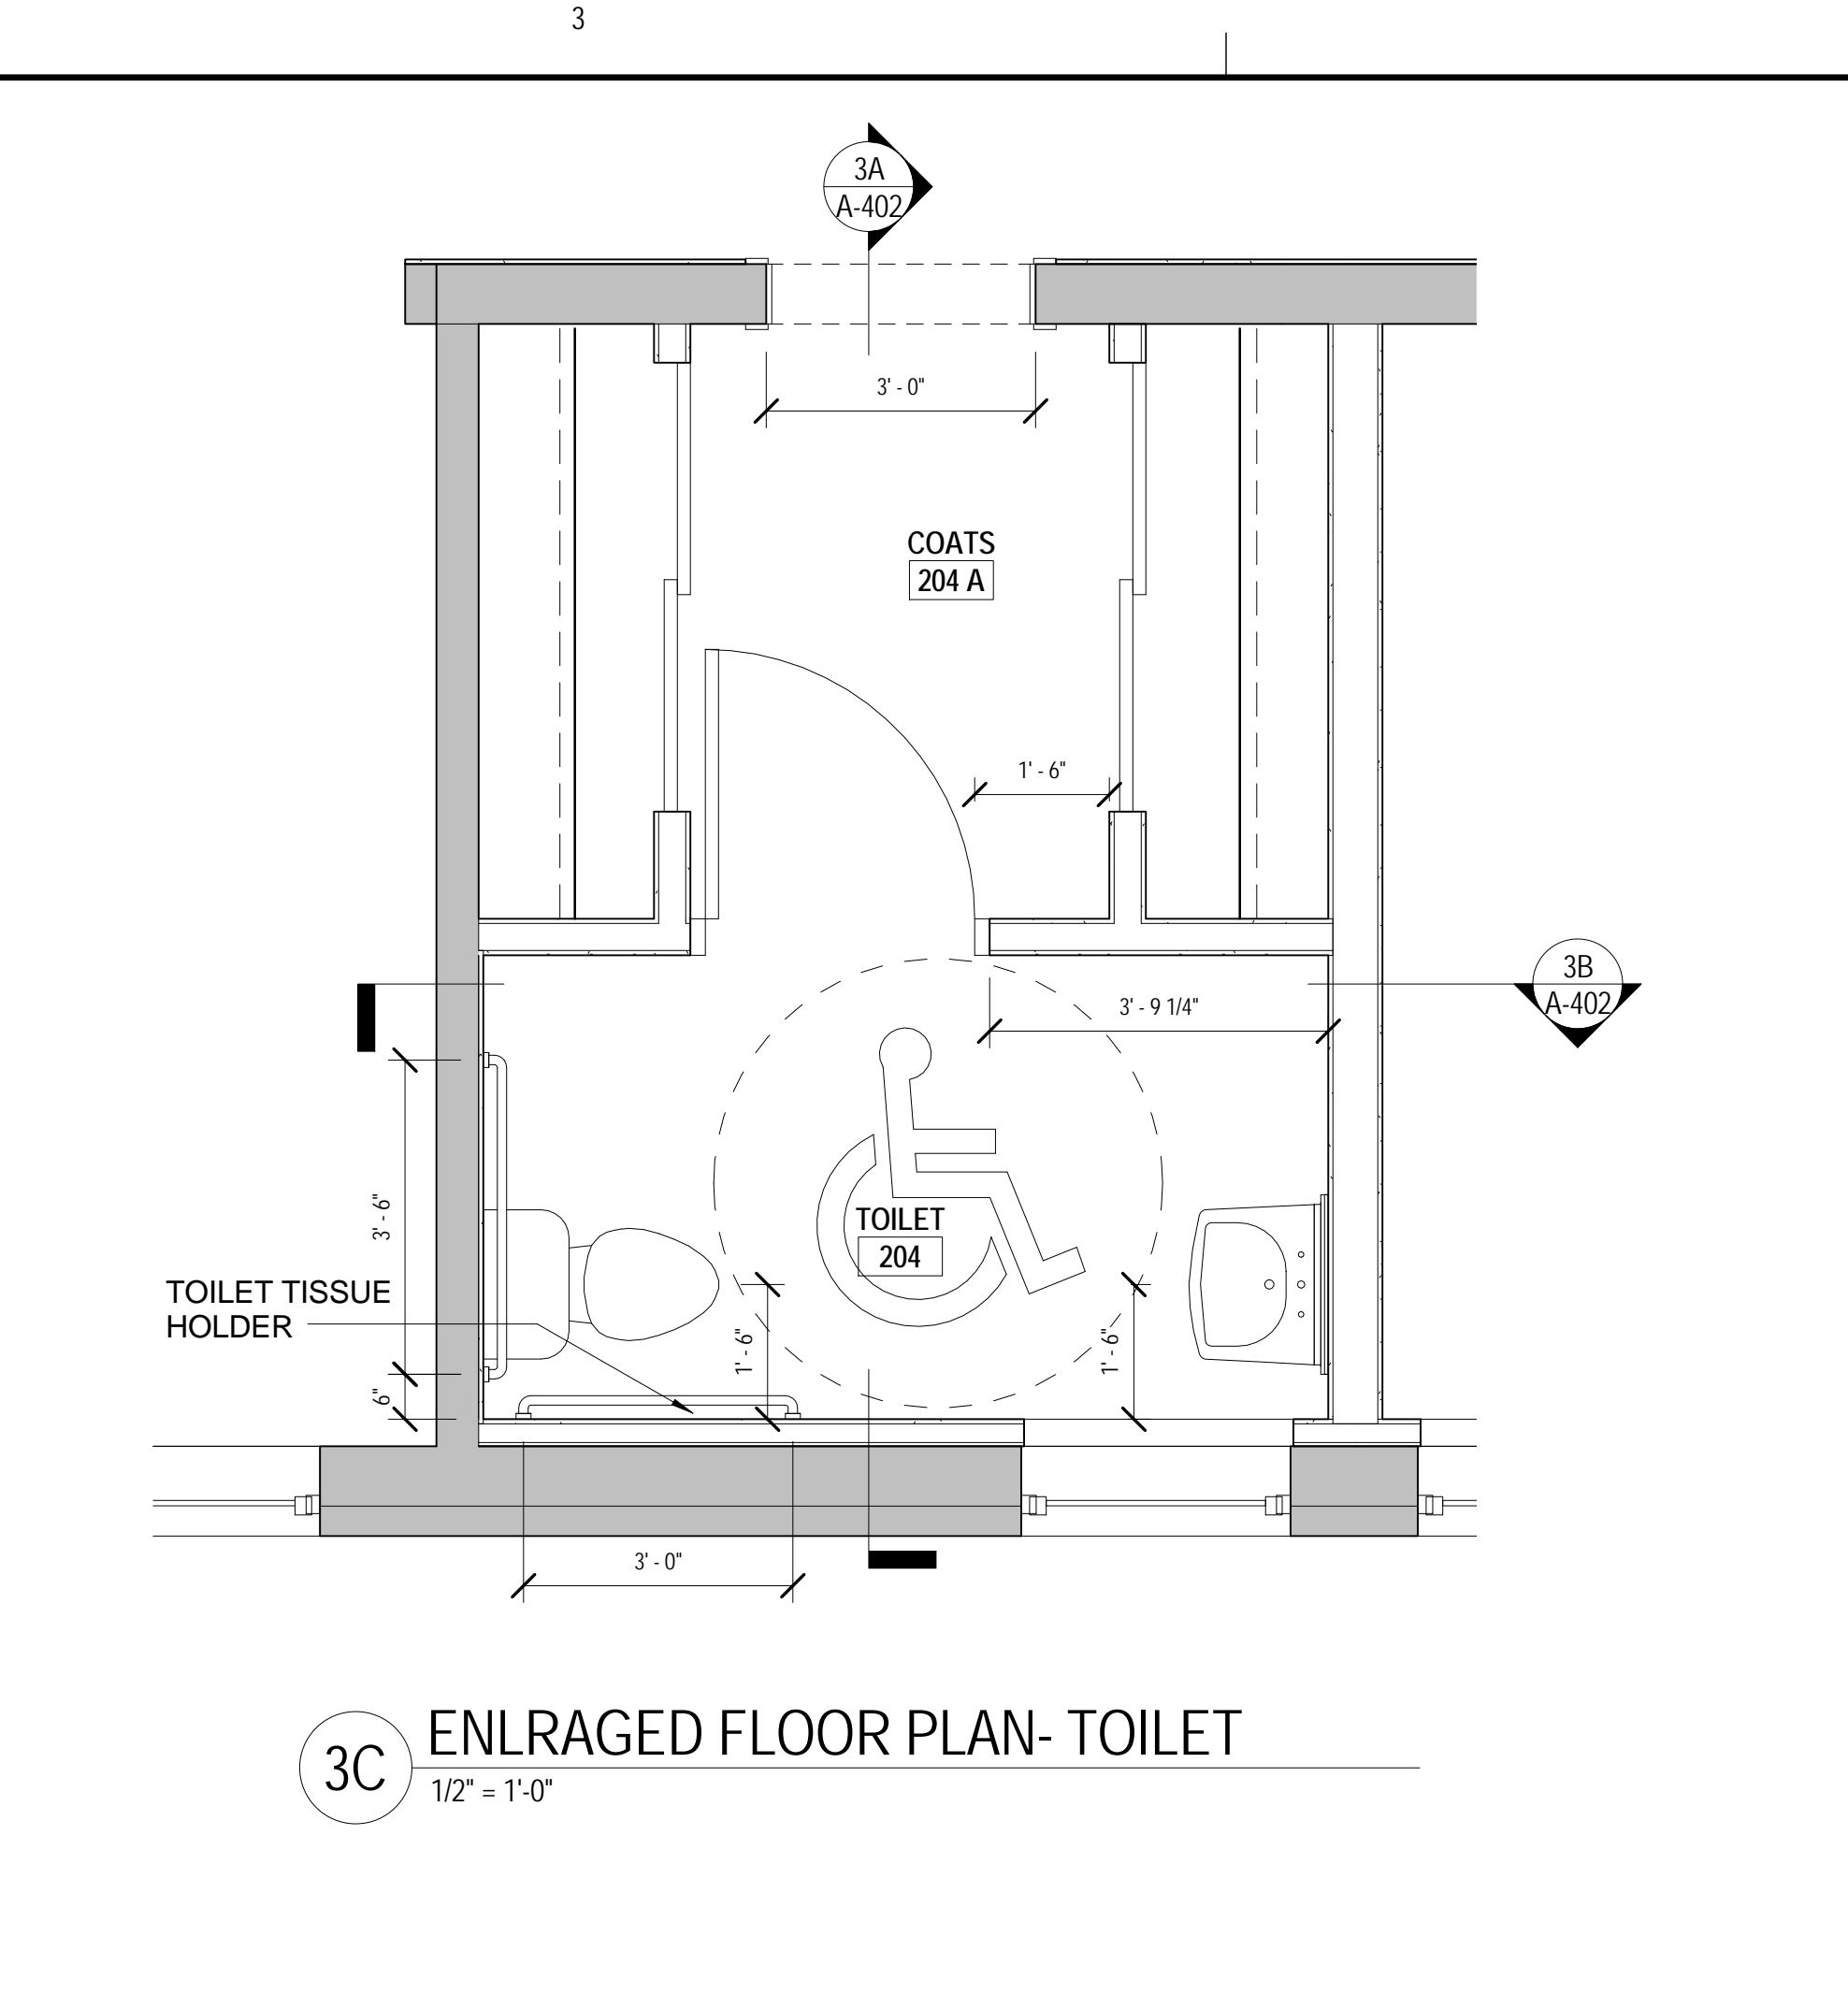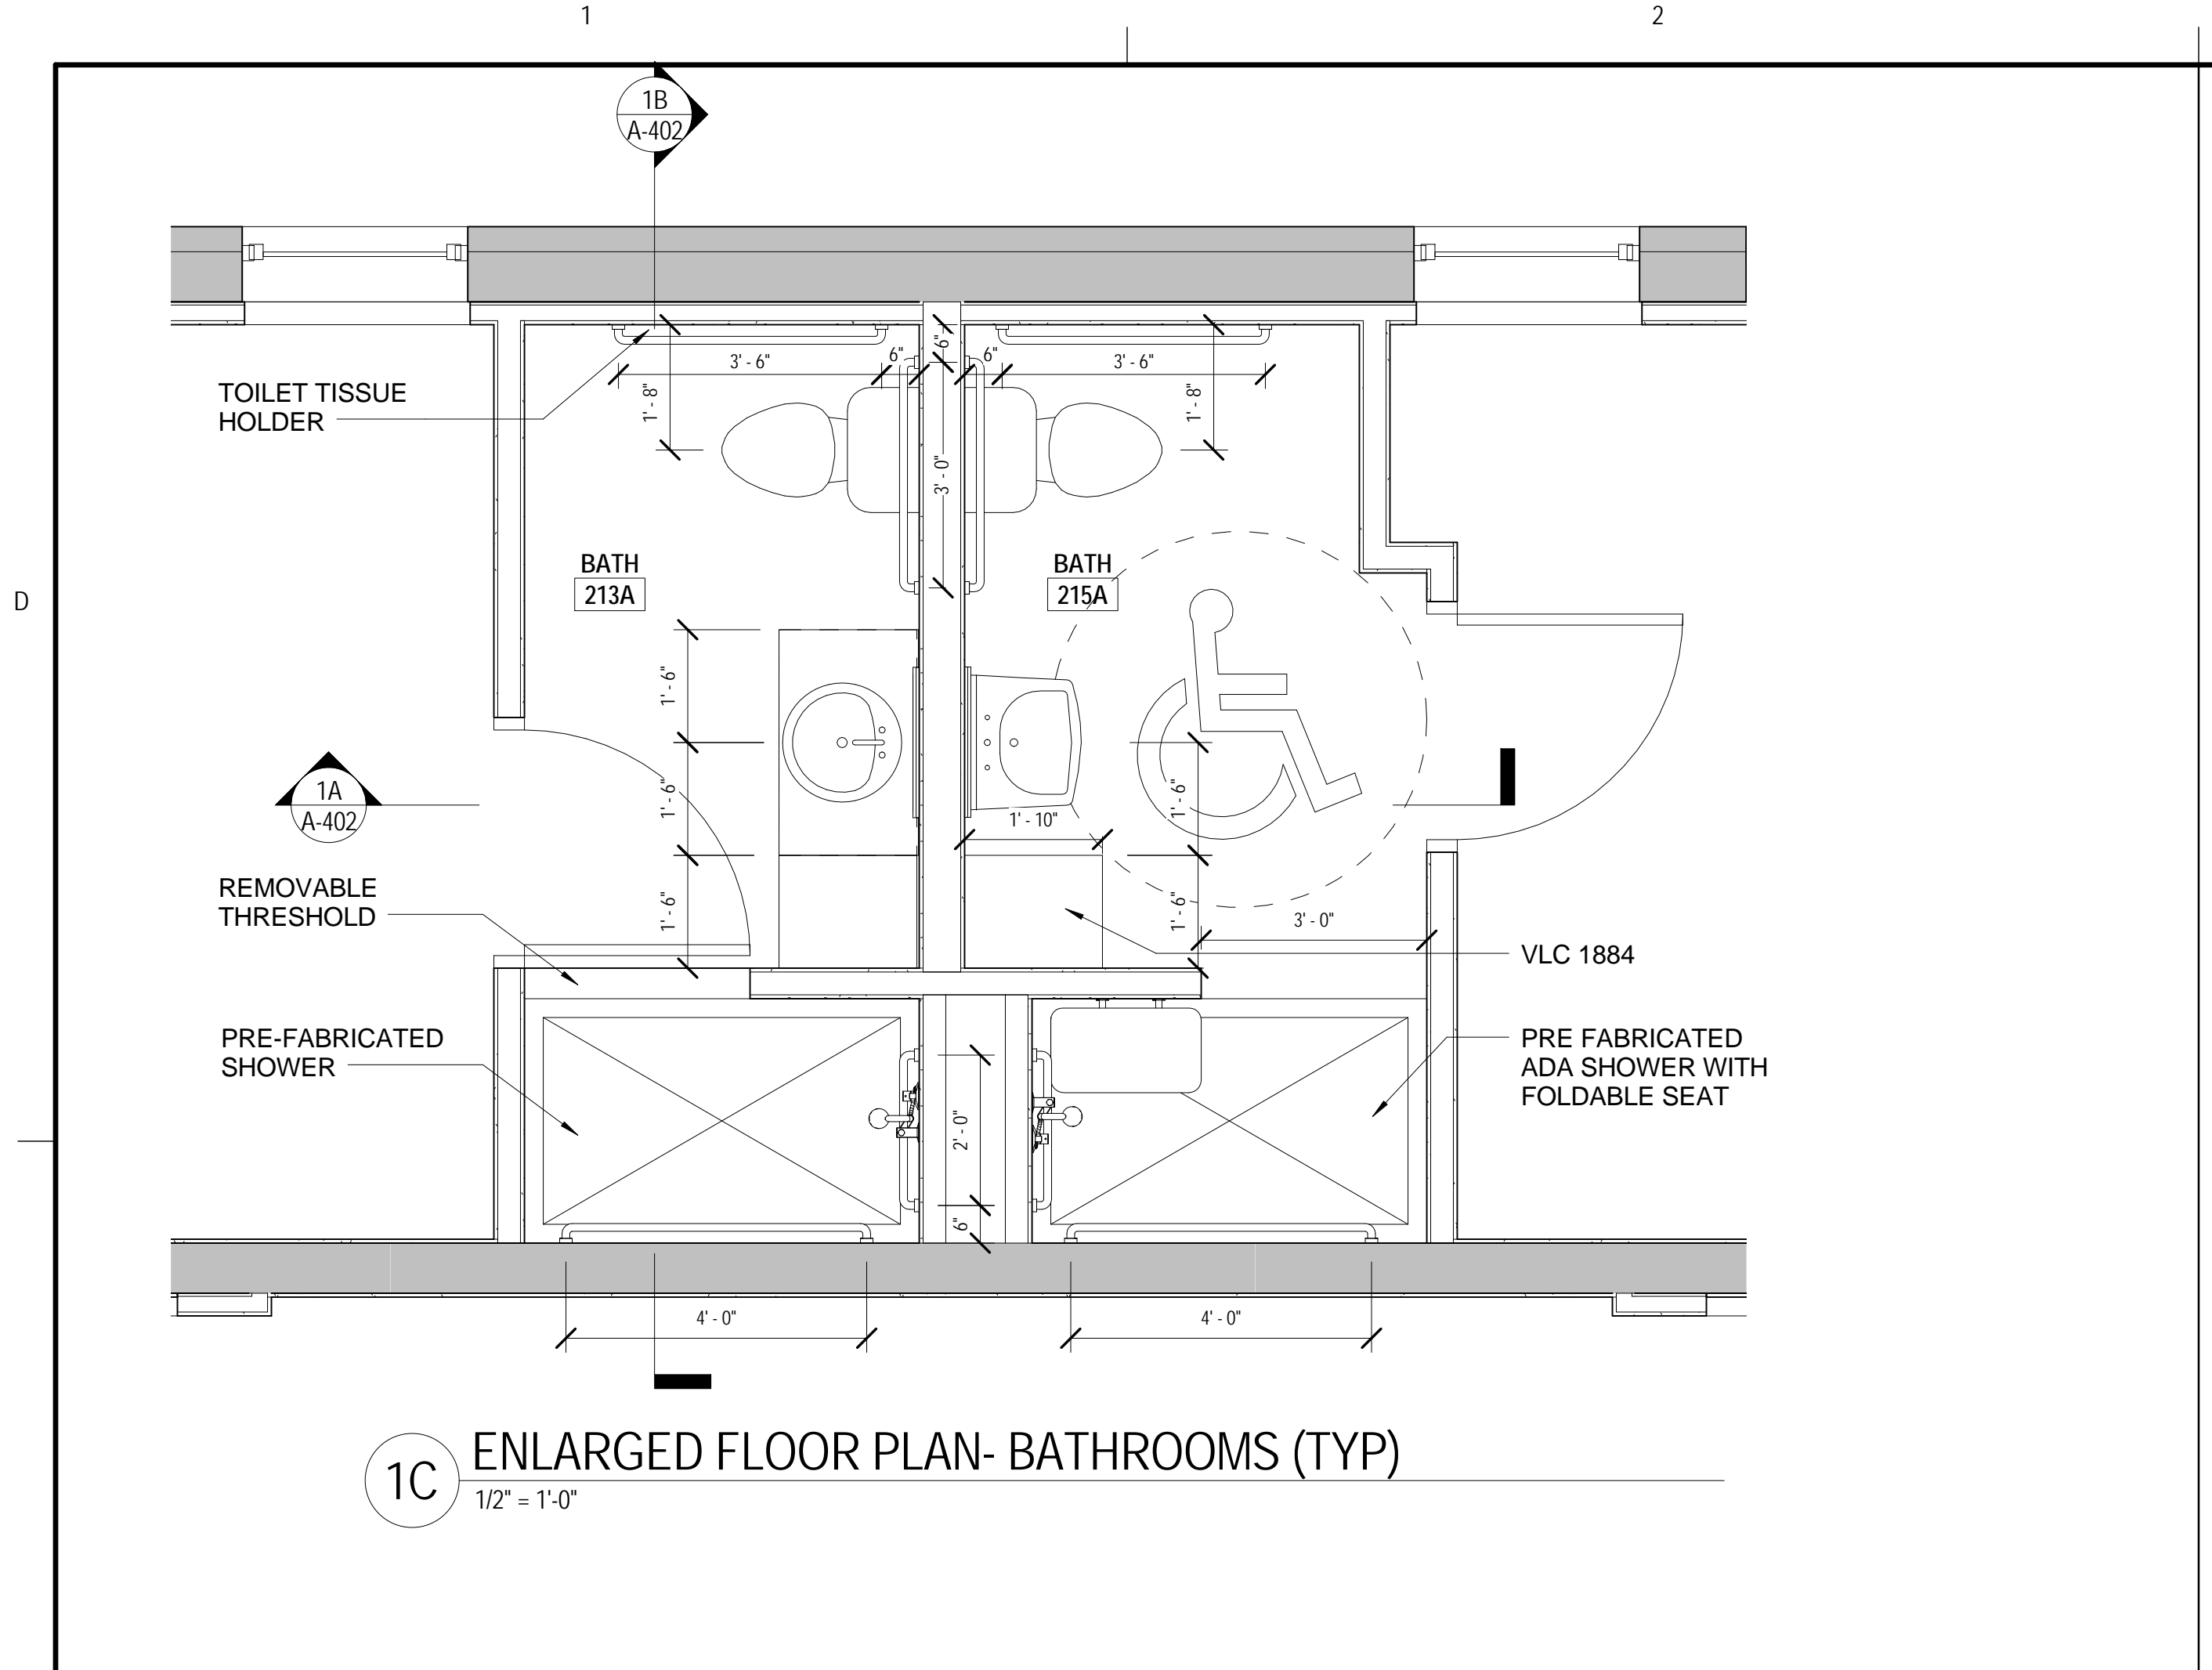

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1	06-17-13	PERMIT SET

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**ENLARGED FLOOR
PLANS, ELEVATIONS
& SECTIONS**

PROJ. NO.: 13007-00	DWG NO
DRAWN BY: Author	A-402
DATE: 06-13-13	

6/18/2013 11:55:55 AM


1

2


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4


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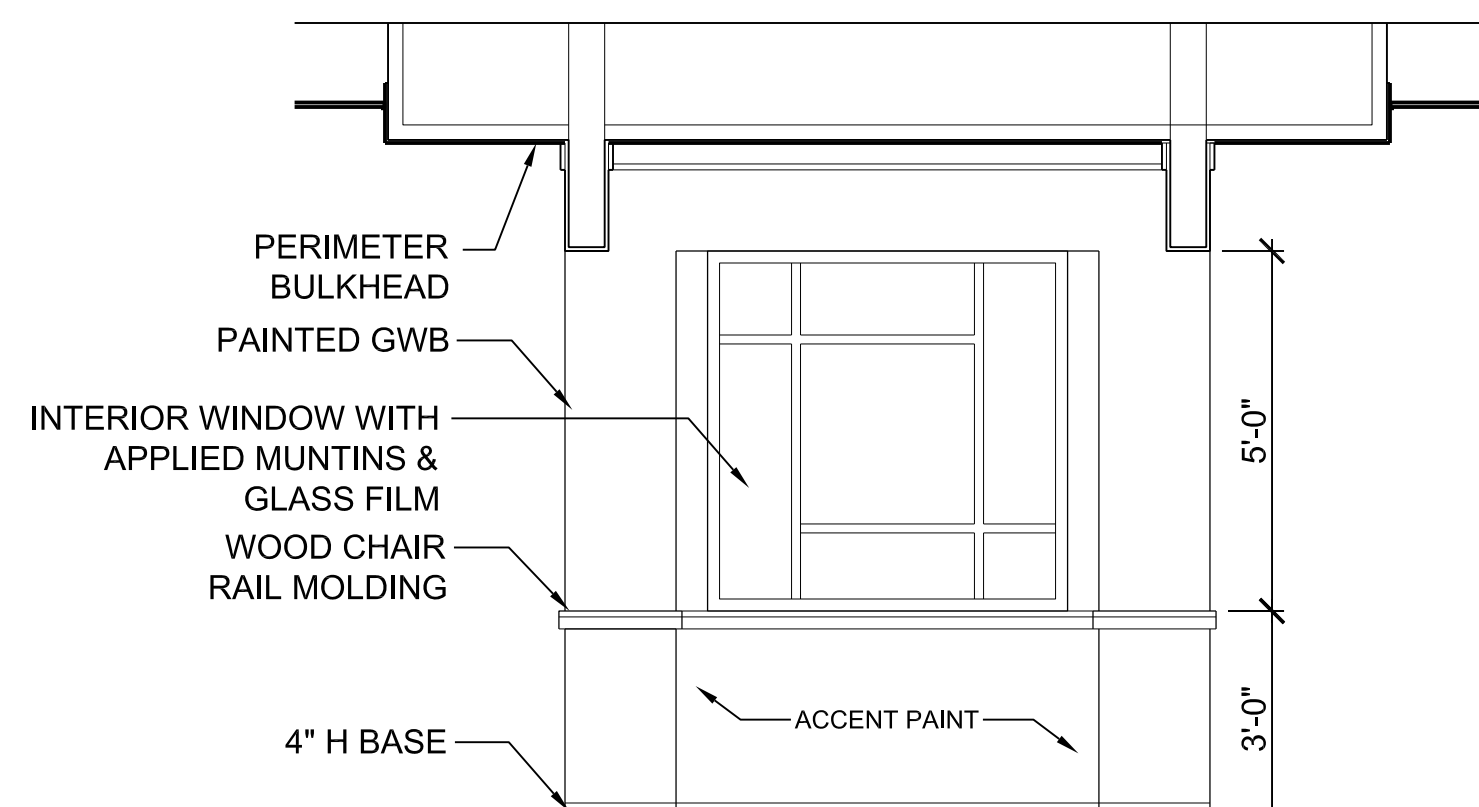
D3 SECTION AT KNEE WALL
3/8" = 1'-0"

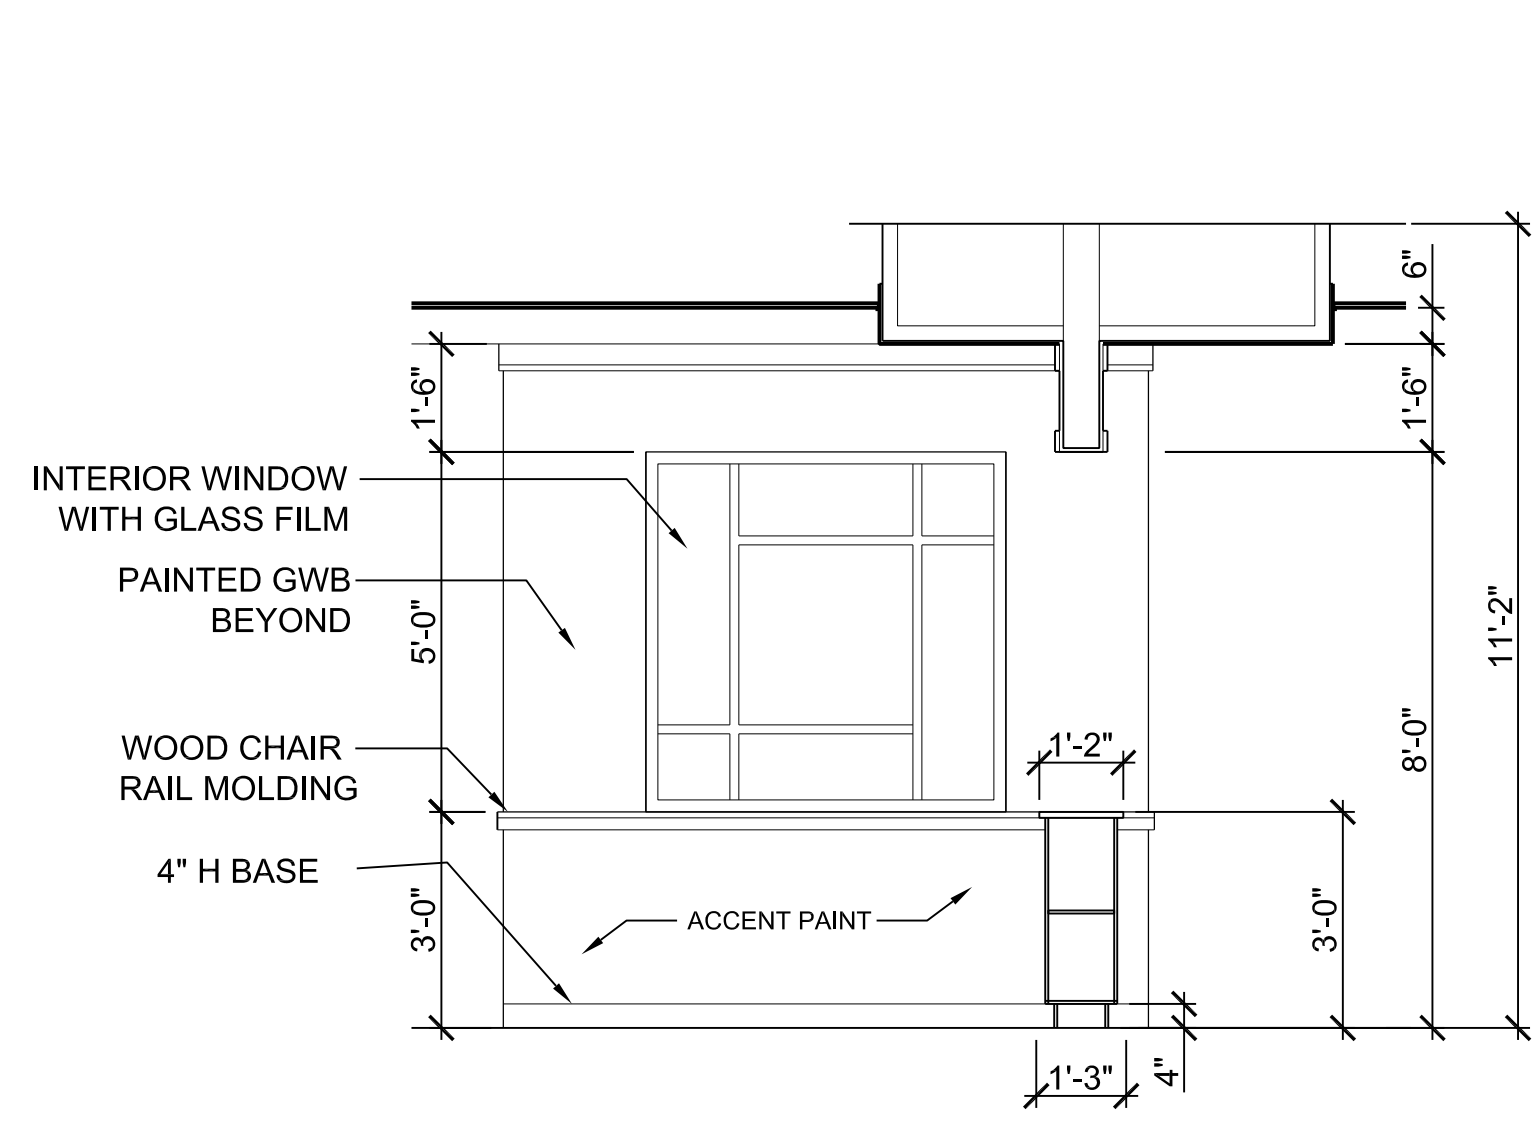


D4 ELEVATION AT KNEE WALL
3/8" = 1'-0"

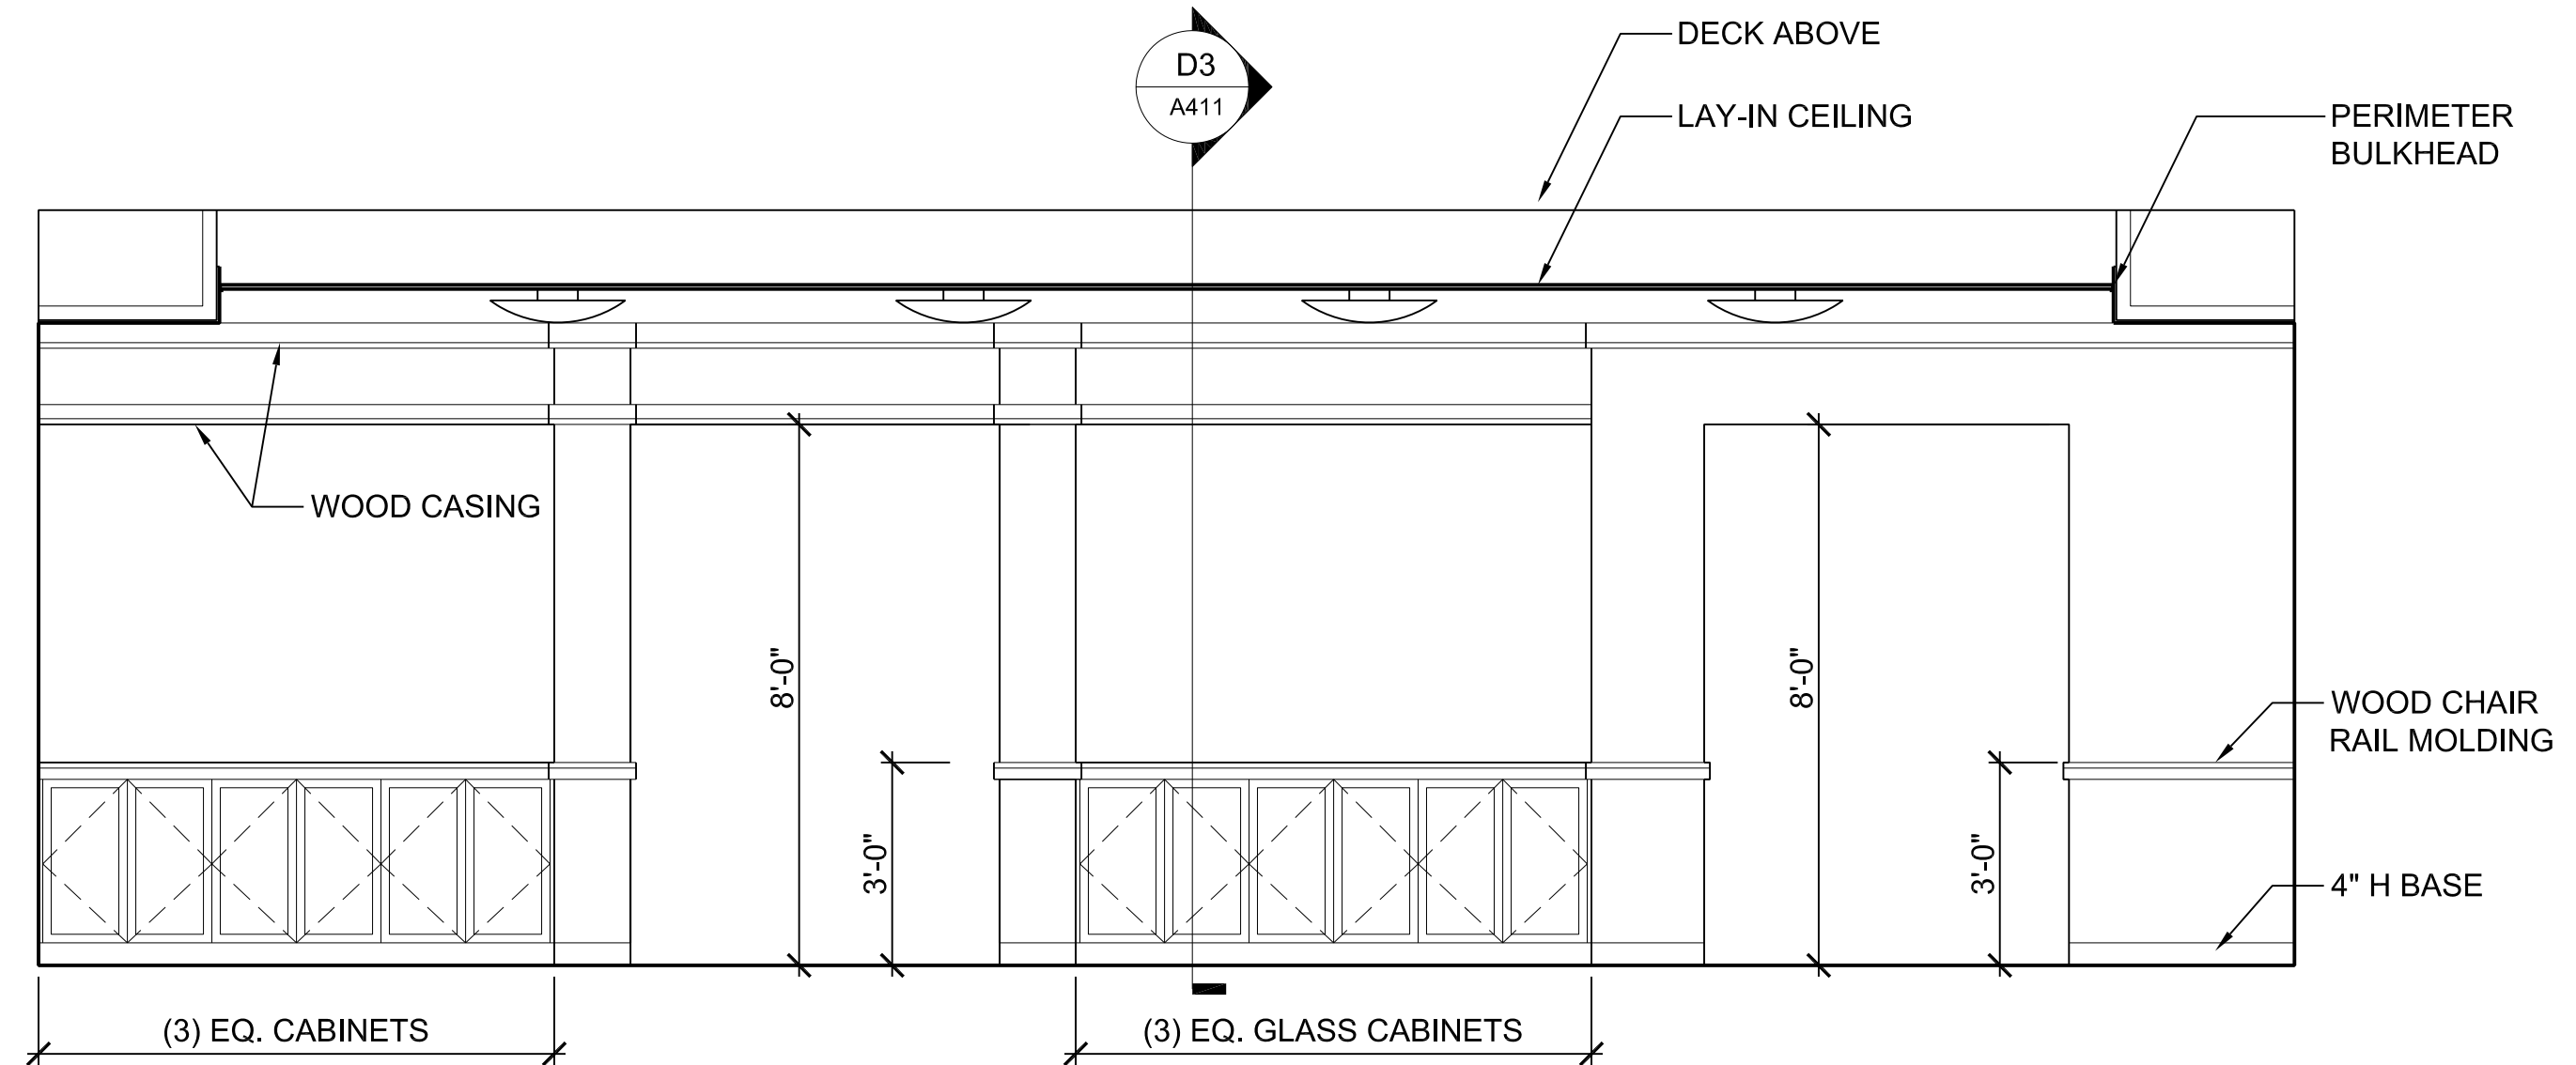


C1 EXISTING WINDOW JAMB
3" = 1'-0"

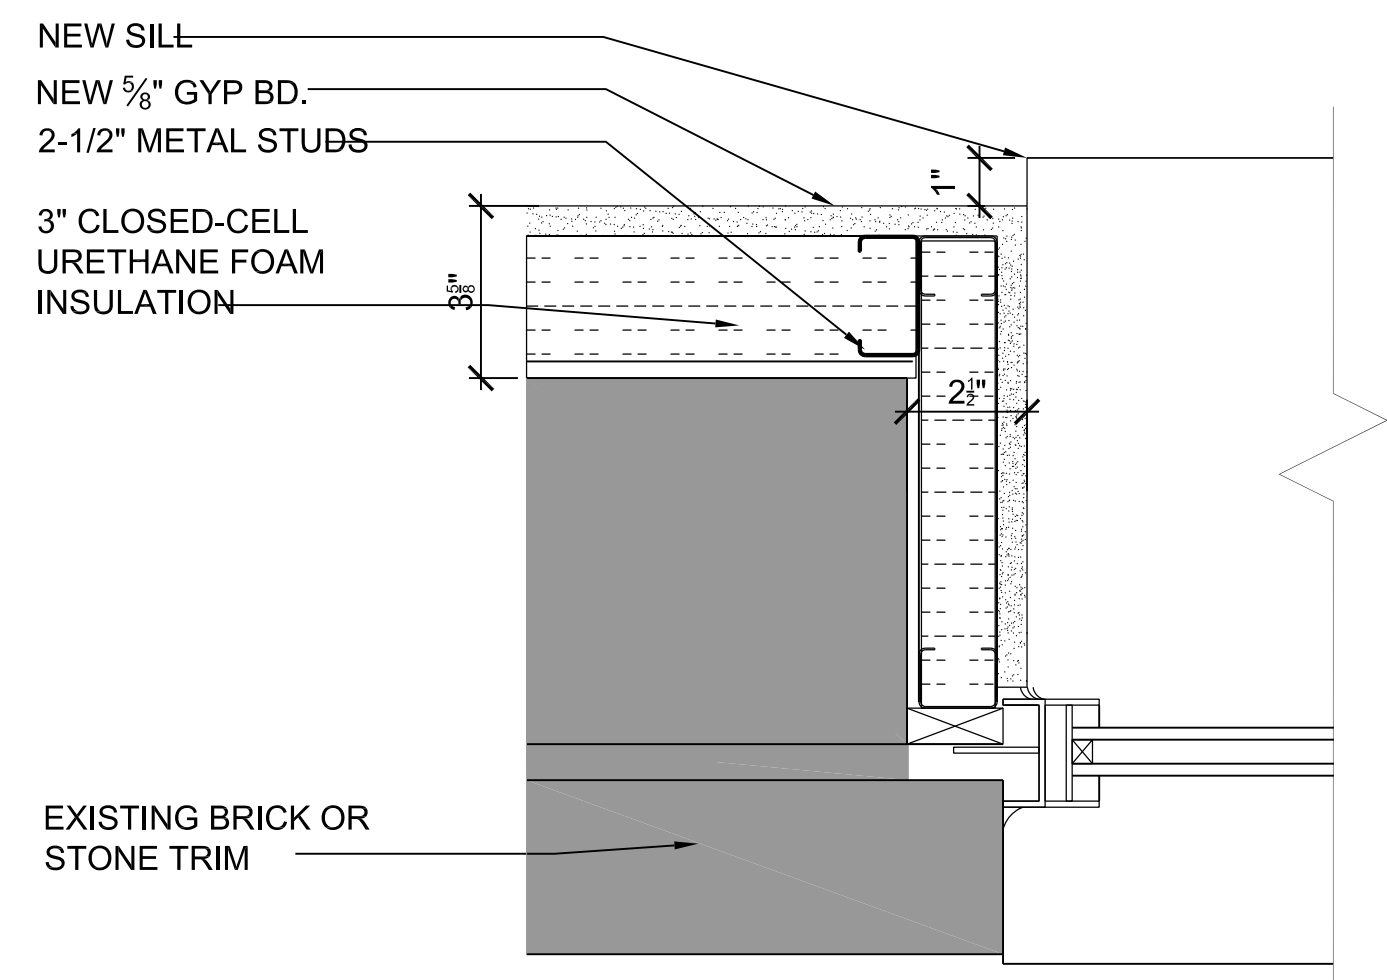


C3 ELEVATION - INTERIOR WINDOW
3/8" = 1'-0"

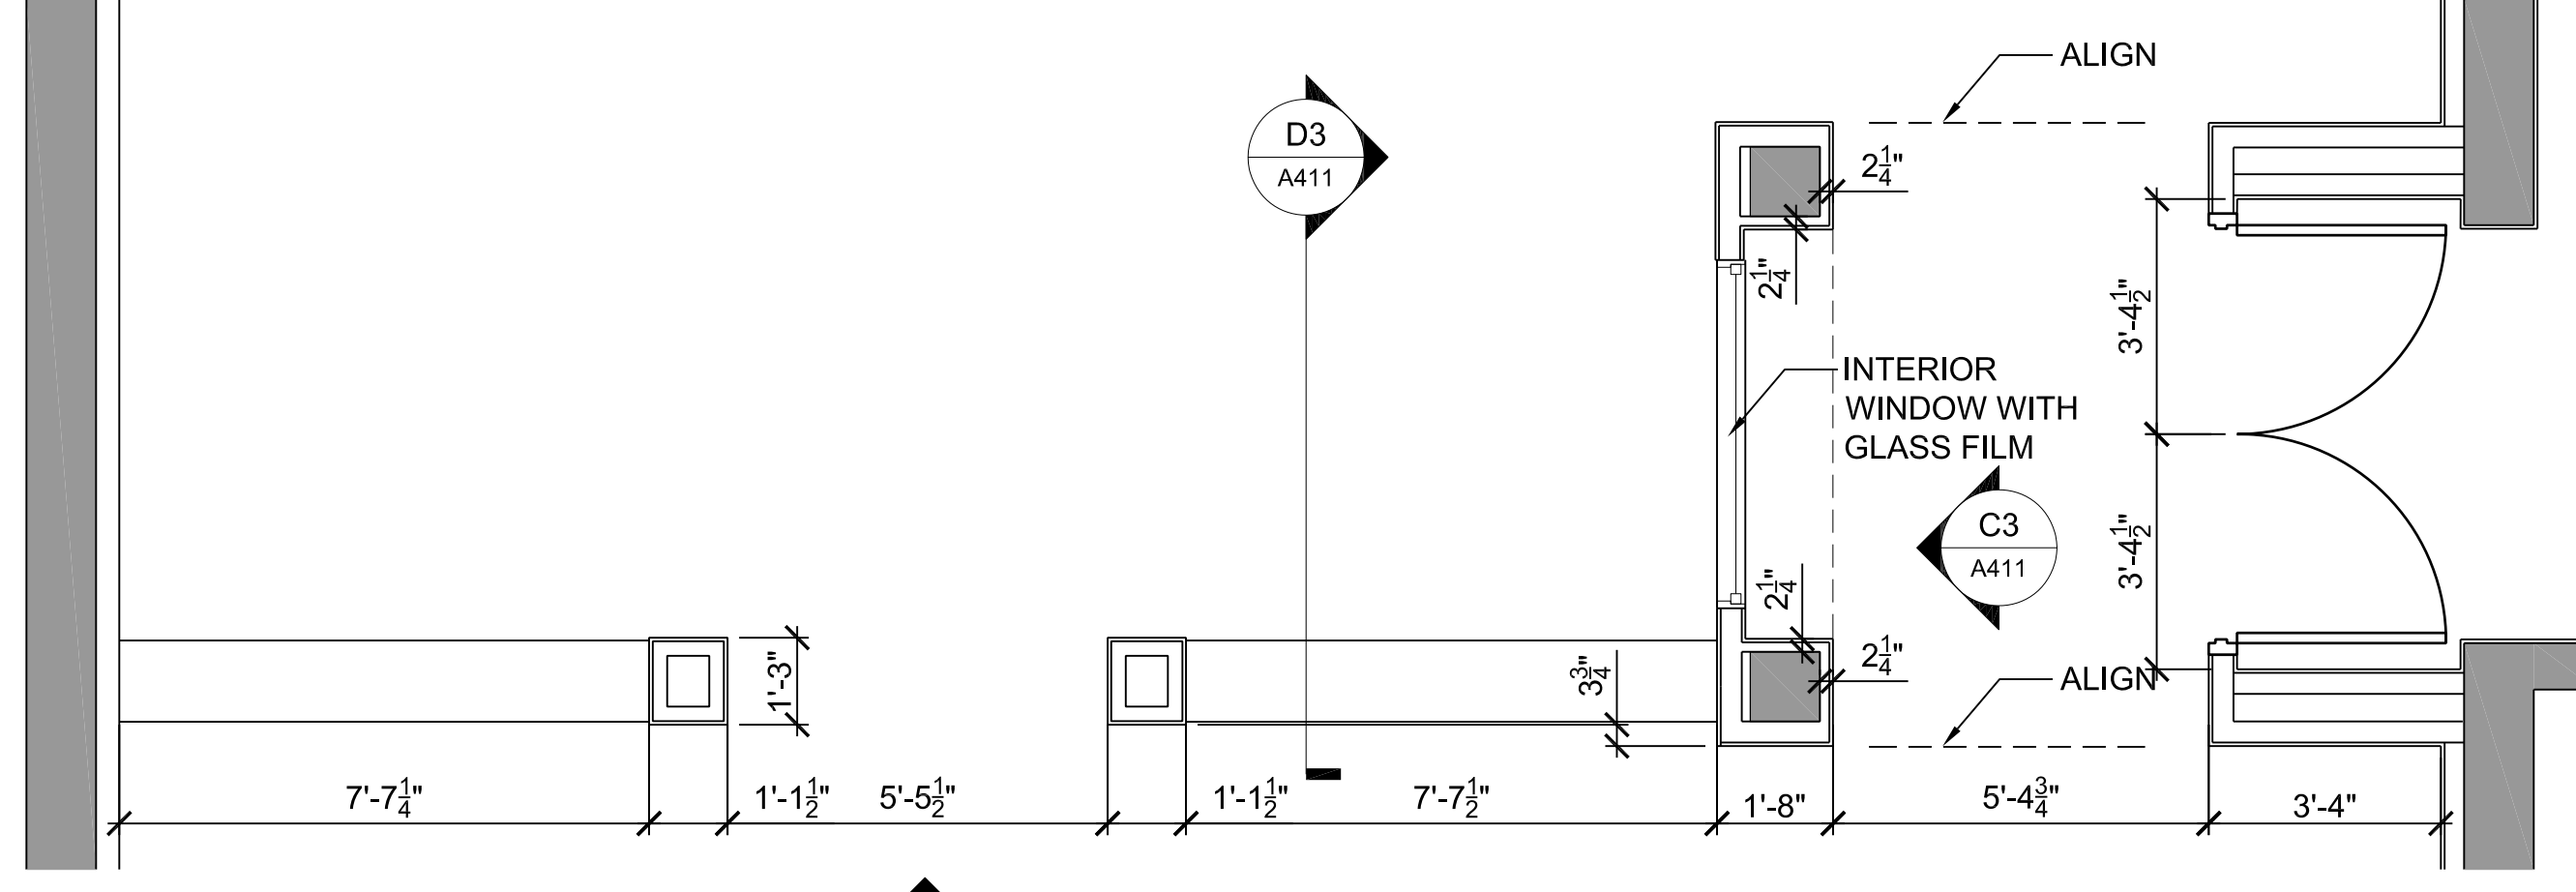


C4 PLAN DETAIL AT COMMUNITY ROOM
3/8" = 1'-0"

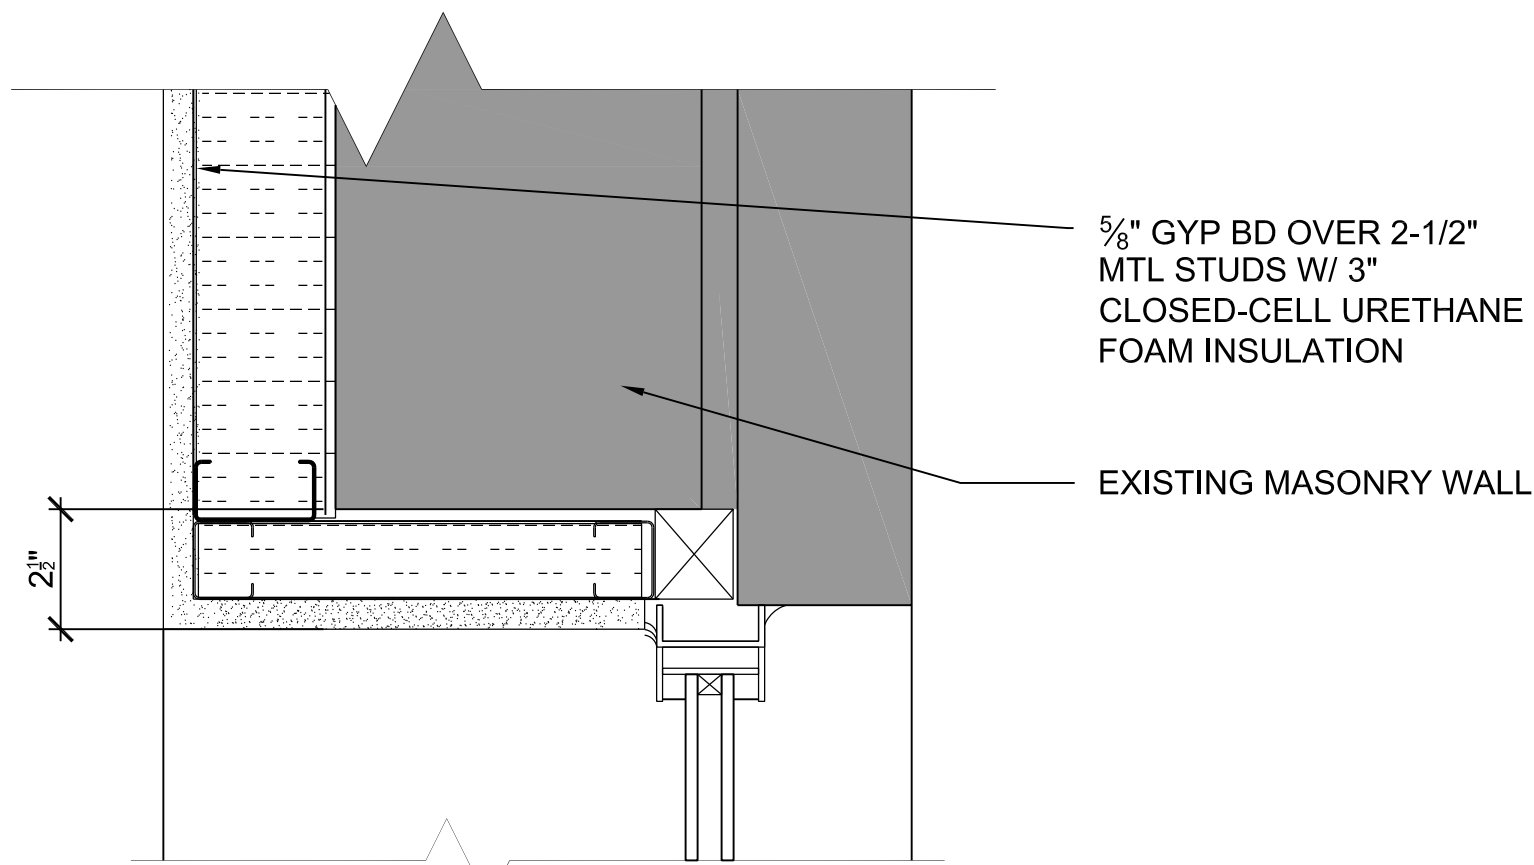


B1 WINDOW HEAD DETAIL
3" = 1'-0"

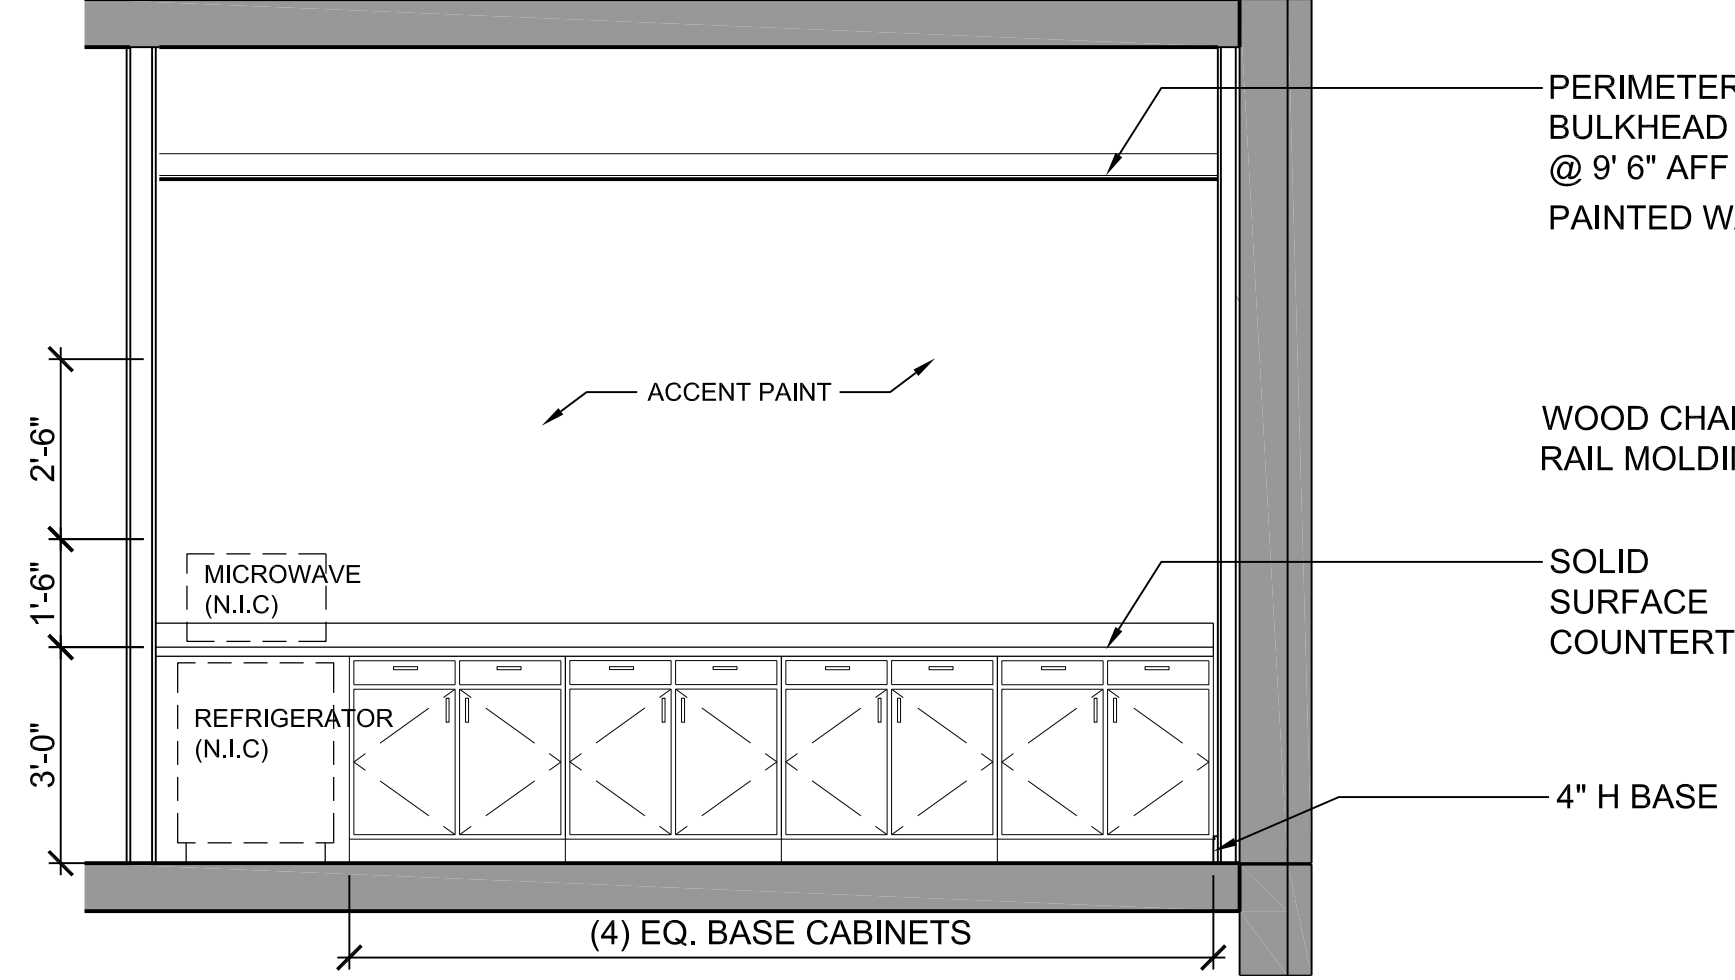


B3 CASEWORK ELEVATION AT DINING ROOM
3/8" = 1'-0"

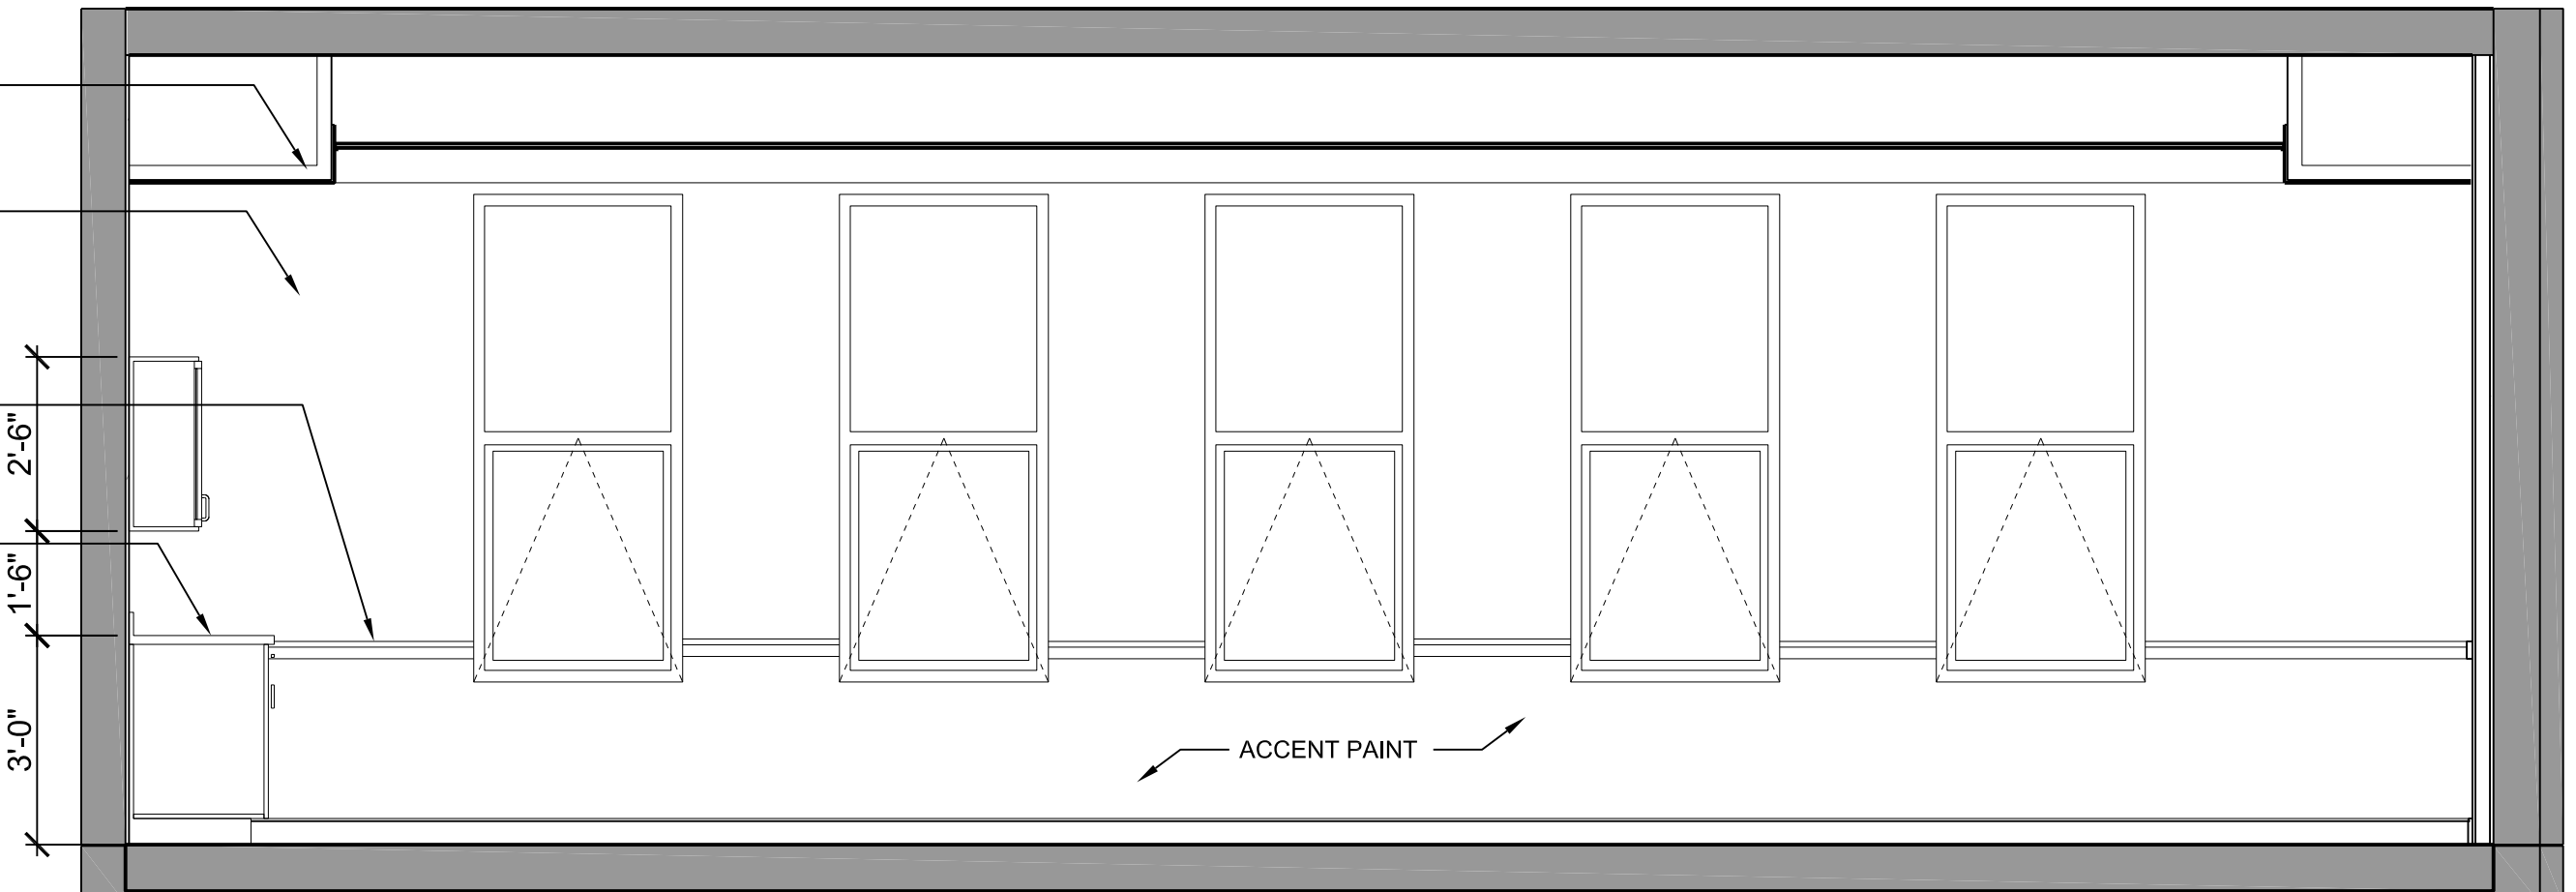

B4 CASEWORK ELEVATION AT DINING ROOM
3/8" = 1'-0"

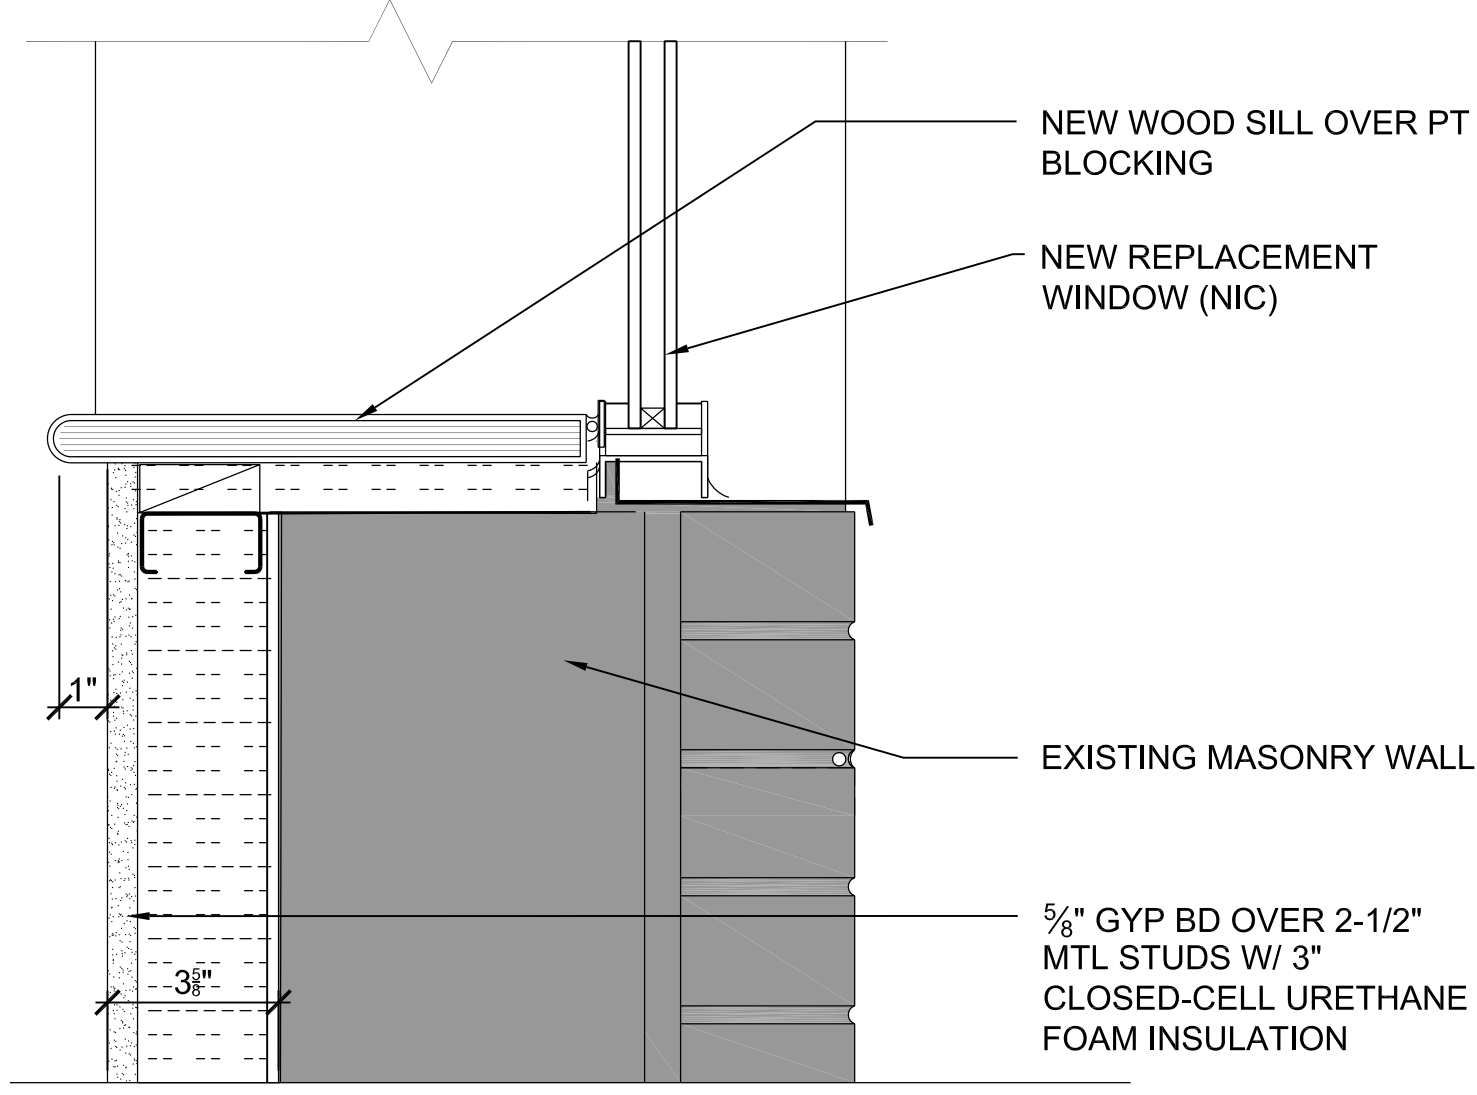

A1 WINDOW SILL DETAIL
3" = 1'-0"

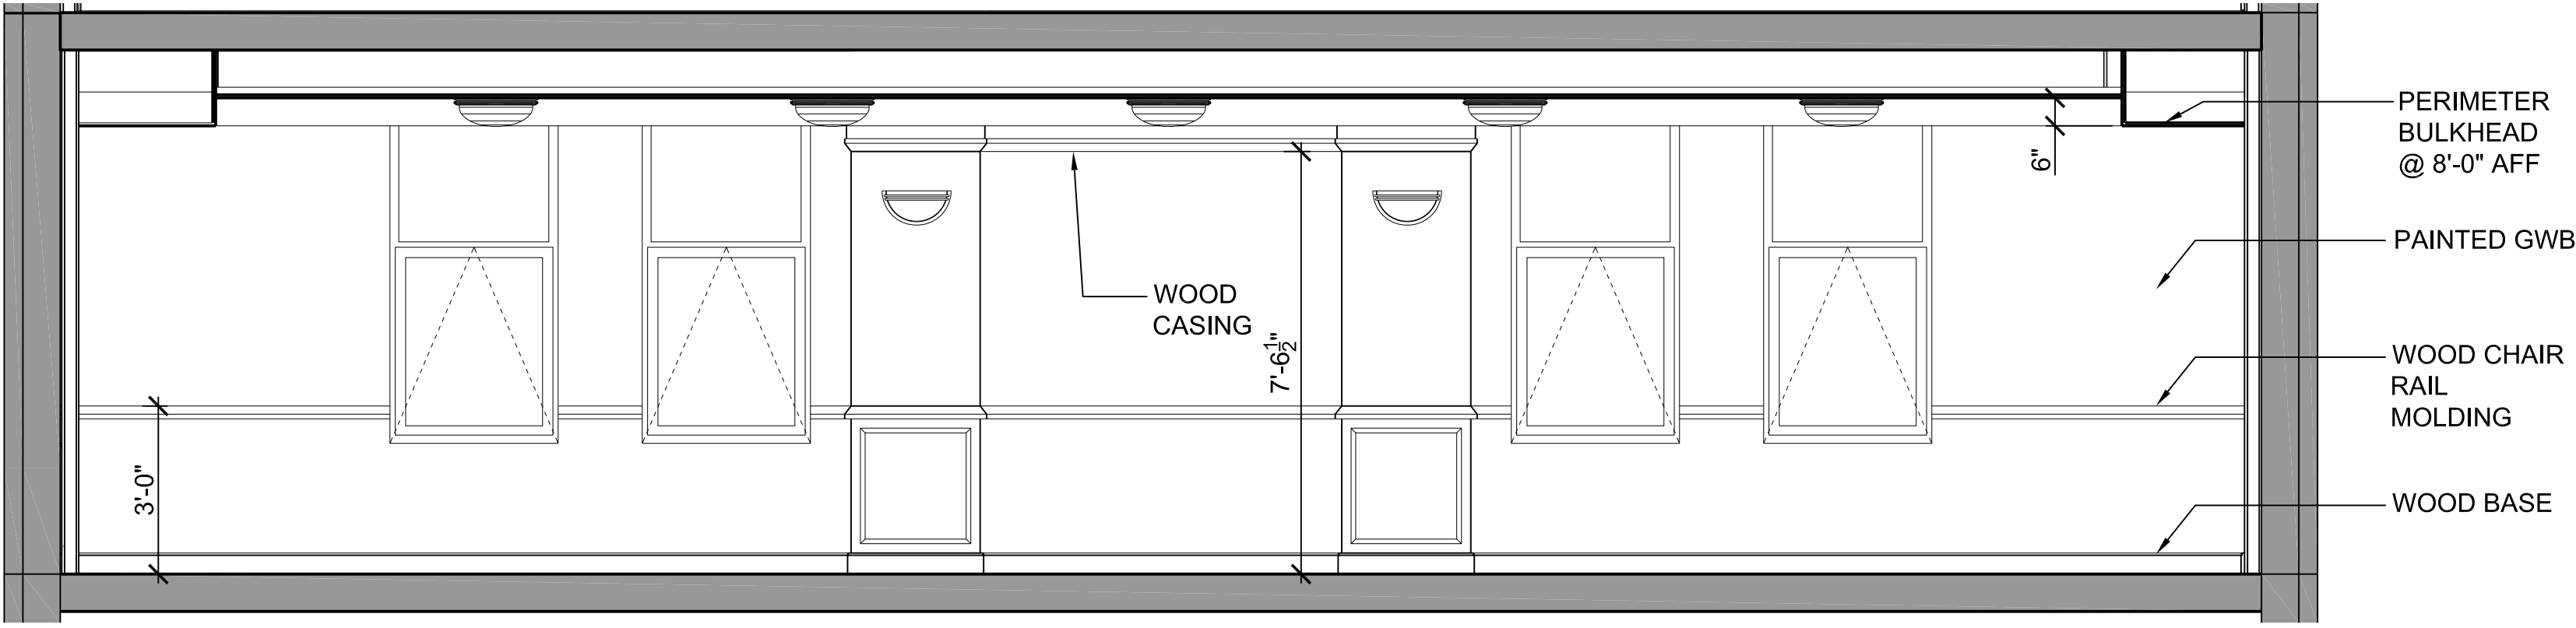

A3 CHAPEL WALL ELEVATION
3/8" = 1'-0"



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DGG: License No:9473 Expiration Date:4/7/2015

NO	DATE	PERMIT SET	DESCRIPTION
1	6-17-13	PERMIT SET	

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INTERIOR ELEVATIONS & DETAILS

PROJ. NO.: 13007-00	DWG NO A-411
DRAWN BY: SRW/AR	
DATE: 6-13-13	

DOOR AND FRAME SCHEDULE

MARK	PANEL				FRAME						FIRE RATING	HARDWARE SET #	REMARKS	
	SIZE			MATL	TYPE	DETAIL			TYPE					
	WIDTH	HEIGHT	THICKNESS			HEAD	JAMB	SILL						
32	3'-0"	7'-2"	0'-1 3/4"	MDF	C	STL	1					60 MIN	HW-4	
32A	3'-0"	7'-2"	0'-1 3/4"	MDF	C	STL	1	H1	J1			60 MIN	HW-4	
32B	3'-0"	7'-2"	0'-1 3/4"	MDF	C	STL	1	H1	J2				HW-4A	
200	5'-4"	7'-2"	0'-1 3/4"	MDF	F		3	H4	J4				HW-6	DOUBLE EGRESS DOOR
201	5'-4"	7'-2"	0'-1 3/4"	MDF	D	STL	2	H1	J1				HW-8	UNEVEN PAIR DOOR
201A	3'-0"	7'-2"	0'-1 3/4"	MDF	C	STL	1	H1	J1				HW-4A	
201B	4'-6"	7'-2"	0'-1 3/4"	MDF	D	STL	2						HW-3	CLOSET DOOR
201C	4'-6"	7'-2"	0'-1 3/4"	MDF	D	STL	2						HW-3	CLOSET DOOR
202	3'-0"	7'-2"	0'-1 3/4"	MDF	A	STL	1	H1	J1				HW-4	
203	3'-0"	7'-2"	0'-1 3/4"	MDF	A	STL	1	H3	J3				HW-4A	
204	3'-0"	7'-2"	0'-1 3/4"	MDF	A	STL	1	H1	J2				HW-9	
204A	5'-0"	7'-2"	0'-1 3/4"	MDF	D								HW-7	CLOSET SLIDING DOOR
204B	5'-0"	7'-2"	0'-1 3/4"	MDF	D								HW-7	CLOSET SLIDING DOOR
205	3'-0"	7'-2"	0'-1 3/4"	MDF	A	STL	1	H3	J3				HW-11	
206	3'-0"	7'-2"	0'-1 3/4"	MDF	A	STL	1						HW-10	
207	3'-0"	7'-2"	0'-1 3/4"	MDF	A	STL	1	H2	J2			45 MIN	HW-1	
207A	3'-0"	7'-2"	0'-1 3/4"	MDF	A	STL	1	H1	J1				HW-2	
207B	4'-6"	7'-2"	0'-1 3/4"	MDF	D	STL	2						HW-3	CLOSET DOOR
208	3'-0"	7'-2"	0'-1 3/4"	MDF	A	STL	1	H2	J2			45 MIN	HW-1	
208A	3'-0"	7'-2"	0'-1 3/4"	MDF	A	STL	1	H1	J1				HW-2	
208B	4'-6"	7'-2"	0'-1 3/4"	MDF	D	STL	2						HW-3	CLOSET DOOR
209	3'-0"	7'-2"	0'-1 3/4"	MDF	A	STL	1	H2	J2			45 MIN	HW-1	
209A	3'-0"	7'-2"	0'-1 3/4"	MDF	A	STL	1	H1	J1				HW-2	
209B	4'-6"	7'-2"	0'-1 3/4"	MDF	D	STL	2						HW-3	CLOSET DOOR
210	3'-0"	7'-2"	0'-1 3/4"	MDF	A	STL	1	H2	J2			45 MIN	HW-1	
210A	3'-0"	7'-2"	0'-1 3/4"	MDF	A	STL	1	H1	J1				HW-2	
210B	4'-6"	7'-2"	0'-1 3/4"	MDF	D	STL	2						HW-3	CLOSET DOOR
211	3'-0"	7'-2"	0'-1 3/4"	MDF	B	STL	1	H3	J3				HW-11	
211A	4'-6"	7'-2"	0'-1 3/4"	MDF	D	STL	2						HW-11	CLOSET DOOR
211B	3'-0"	7'-2"	0'-1 3/4"	GLASS	B	STL	1						-	FIXED PANEL NO HARDWARE
211C	3'-0"	7'-2"	0'-1 3/4"	GLASS	B	STL	1						-	FIXED PANEL NO HARDWARE
212	3'-0"	7'-2"	0'-1 3/4"	MDF	B	STL	1	H3	J3				HW-11	
212A	3'-0"	7'-2"	0'-1 3/4"	MDF	B	STL	1						-	FIXED PANEL NO HARDWARE
212B	3'-0"	7'-2"	0'-1 3/4"	MDF	B	STL	1						-	FIXED PANEL NO HARDWARE
213	3'-0"	7'-2"	0'-1 3/4"	MDF	A	STL	1	H2	J2			45 MIN	HW-1	
213A	3'-0"	7'-2"	0'-1 3/4"	MDF	A	STL	1	H1	J1				HW-2	
213B	4'-6"	7'-2"	0'-1 3/4"	MDF	D	STL	2						HW-3	CLOSET DOOR
214	3'-0"	7'-2"	0'-1 3/4"	MDF	A	STL	1	H2	J2			45 MIN	HW-1	
214A	3'-0"	7'-2"	0'-1 3/4"	MDF	A	STL	1	H1	J1				HW-2	
214B	4'-6"	7'-2"	0'-1 3/4"	MDF	D	STL	2						HW-3	CLOSET DOOR
215	3'-0"	7'-2"	0'-1 3/4"	MDF	A	STL	1	H2	J2			45 MIN	HW-1	
215A	3'-0"	7'-2"	0'-1 3/4"	MDF	A	STL	1	H1	J1				HW-2	
215B	4'-0"	7'-2"	0'-1 3/4"	MDF	D								HW-7	CLOSET SLIDING DOOR
216	3'-0"	7'-2"	0'-1 3/4"	MDF	A	STL	1	H2	J2			45 MIN	HW-1	
216A	3'-0"	7'-2"	0'-1 3/4"	MDF	A	STL	1	H1	J1				HW-2	
216B	4'-0"	7'-2"	0'-1 3/4"	MDF	D								HW-7	CLOSET SLIDING DOOR
33	3'-0"	7'-2"	0'-1 3/4"	MDF	C	STL	1					60 MIN	HW-4	
33A	3'-0"	7'-2"	0'-1 3/4"	MDF	C	STL	1	H1	J1			60 MIN	HW-4	
33B	3'-0"	7'-2"	0'-1 3/4"	MDF	C	STL	1	H1	J1				HW-4A	
300	5'-4"	7'-2"	0'-1 3/4"	MDF				H4	J4					
301	6'-0"	7'-2"	0'-1 3/4"	MDF	E	STL	2	H1	J1				HW-8	PAIR DOOR
304	3'-0"	7'-2"	0'-1 3/4"	MDF	A	STL	1	H1	J1				HW-9	
304A	5'-0"	7'-2"	0'-1 3/4"	MDF	D								HW-7	CLOSET SLIDING DOOR
304B	5'-0"	7'-2"	0'-1 3/4"	MDF	D								HW-7	CLOSET SLIDING DOOR
306	3'-0"	7'-2"	0'-1 3/4"	MDF	A	STL	1	H3	J3				HW-10	
307	3'-0"	7'-2"	0'-1 3/4"	MDF	A	STL	1	H2	J2			45 MIN	HW-1	
307A	3'-0"	7'-2"	0'-1 3/4"	MDF	A	STL	1	H1	J1				HW-2	
307B	4'-6"	7'-2"	0'-1 3/4"	MDF	D	STL	2						HW-3	CLOSET DOOR
308	3'-0"	7'-2"	0'-1 3/4"	MDF	A	STL	1	H2	J2			45 MIN	HW-1	
308A	3'-0"	7'-2"	0'-1 3/4"	MDF	A	STL	1	H1	J1				HW-2	
308B	4'-6"	7'-2"	0'-1 3/4"	MDF	D	STL	2						HW-3	CLOSET DOOR
309	3'-0"	7'-2"	0'-1 3/4"	MDF	A	STL	1	H2	J2			45 MIN	HW-1	
309A	3'-0"	7'-2"	0'-1 3/4"	MDF	A	STL	1	H1	J1				HW-2	
309B	4'-6"	7'-2"	0'-1 3/4"	MDF	D	STL	2						HW-3	CLOSET DOOR
310	3'-0"	7'-2"	0'-1 3/4"	MDF	A	STL	1	H2	J2			45 MIN	HW-1	
310A	3'-0"	7'-2"	0'-1 3/4"	MDF	A	STL	1	H1	J1				HW-2	
310B	4'-6"	7'-2"	0'-1 3/4"	MDF	D	STL	2						HW-3	CLOSET DOOR
311	3'-0"	7'-2"	0'-1 3/4"	GLASS	B	STL	1	H3	J3				HW-11	
311A	4'-6"	7'-2"	0'-1 3/4"	MDF	D	STL	2						HW-4	
311B	3'-0"	7'-2"	0'-1 3/4"	GLASS	B	STL	1						-	FIXED PANEL NO HARDWARE
311C	3'-0"	7'-2"	0'-1 3/4"	GLASS	B	STL	1						-	FIXED PANEL NO HARDWARE
312	3'-0"	7'-2"	0'-1 3/4"	GLASS	B	STL	1	H3	J3				HW-11	
312A	3'-0"	7'-2"	0'-1 3/4"	GLASS	B	STL	1						-	FIXED PANEL NO HARDWARE
312B	3'-0"	7'-2"	0'-1 3/4"	GLASS	B	STL	1						-	FIXED PANEL NO HARDWARE
313	3'-0"	7'-0"	0'-1 3/4"	MDF	A	STL	1	H2	J2			45 MIN	HW-1	
313A	3'-0"	7'-2"	0'-1 3/4"	MDF	A	STL	2	H1	J1				HW-2	
313B	4'-6"	7'-2"	0'-1 3/4"	MDF	D	STL	2						HW-3	CLOSET DOOR
314	3'-0"	7'-2"	0'-1 3/4"	MDF	A	STL	1	H2	J2			45 MIN	HW-1	
314A	3'-0"	7'-2"	0'-1 3/4"	MDF	A	STL	1	H1	J1				HW-2	
314B	4'-6"	7'-2"	0'-1 3/4"	MDF	D	STL	2						HW-3	CLOSET DOOR
315	3'-0"	7'-2"	0'-1 3/4"	MDF	A	STL	1	H2	J2			45 MIN	HW-1	
315A	3'-0"	7'-2"	0'-1 3/4"	MDF	A	STL	1	H1	J1				HW-2	
315B	4'-0"	7'-2"	0'-1 3/4"	MDF	D								HW-7	CLOSET SLIDING DOOR
316	3'-0"	7'-2"	0'-1 3/4"	MDF	A	STL	1	H2	J2			45 MIN	HW-1	
316A	3'-0"	7'-2"	0'-1 3/4"	MDF	A	STL	1	H1	J1				HW-2	
316B	4'-0"	7'-2"	0'-1 3/4"	MDF	D								HW-7	CLOSET SLIDING DOOR

HARDWARE SCHEDULE

HW-1	BEDROOM
1	PRIVACY LOCKSET W/ LEVER HANDLES
3	SPRING HINGES
1 SET	SILENCERS
HW-2	BATHROOM
1	PASSAGE LATCHSET W/ LEVER HANDLES
3	HINGES
1 SET	SILENCERS
1	ROBE HOOK
HW-3	CLOSET DOORS (SWINGING)
1	DUMMY LEVERS
3	HINGES
1 SET	SILENCERS
HW-4	LOCKED STORAGE
1	ENTRANCE LOCKSET W/ LEVER HANDLES
3	SPRING HINGES
1 SET	SILENCERS
2	KICK PLATES
HW-4A	UNLOCKED STORAGE
1	PASSAGE LATCHSET W/ LEVER HANDLES
3	SPRING HINGES
1 SET	SILENCERS
HW-5	EXISTING SINGLE STAIR DOOR
1	NEW DOOR LEVERS (REPLACE EXISTING)
1	NEW SURFACE MOUNTED CLOSER
HW-6	DOUBLE EGRESS (HARDWARE BY DOOR SUPPLIER)
2	LOW PROFILE EXIT DEVICES/ DOOR LEVERS
2	CONTINUOUS HINGES
1 SET	SILENCERS
2	HOLD-OPENS CONNECTED TO FIRE ALARM
4	KICK PLATES
HW-7	CLOSET DOOR (SLIDING)
2	DOOR PULLS
1	SLIDING DOOR TRACK/ HARDWARE
HW-8	CHAPEL/ COMMUNITY ROOM
2	EXIT DEVICES/ DOOR LEVERS
6	HEAVY DUTY HINGES
1 SET	SILENCERS
2	HOLD-OPENS/ STOPS
4	KICK PLATES
HW-9	TOILET
1	PRIVACY LOCKSET W/ LEVER HANDLES
3	SPRING HINGES
1 SET	SILENCERS
HW-10	LAUNDRY
1	PASSAGE LATCHSET W/ LEVER HANDLES
3	HINGES
1 SET	SILENCERS
2	KICK PLATES
HW-11	MISC. PRIVATE ROOM
1	PASSAGE LATCHSET W/ LEVER HANDLES
3	SPRING HINGES
1 SET	SILENCERS
2	KICK PLATES
HW-12	EXTERIOR STAIR DOOR
1	EXIT DEVICE/ EXTERIOR DOOR LEVER
3	HEAVY DUTY HINGES
1	KICK PLATE
1	SET WEATHERSTRIPPING

FINISH SCHEDULE

ROOM NO.	ROOM NAME	FLOOR	BASE	FINISHES			CLG.	CLG. MATL.	REMARKS
				WALL	WAINSCOT				
200	CORRIDOR	CPT-1	WOOD	PT			FACTORY	APC	CARPET BORDER CPT-7
200 A	JANITOR	SLR		PT					
200 B	CLOSET	CPT	VB	PT					
201	CHAPEL	CPT-2	WOOD	PT	WD		FACTORY	APC - GB	CARPET BORDER CPT-7
201A	STORAGE	CPT	VB	PT			FACTORY	APC	
202	SACRISTY	CPT	VB	PT			FACTORY		
203	STORAGE	LVT	VB	PT				APC	
204	TOILET	CT-1	CT-3	PT		CT-3	PT	GB	4" BORDER OF CT-4
204 A	COATS	CPT-1	VB	PT			FACTORY	APC	
205	MEETING ROOM	CPT-1	VB	PT			FACTORY	APC	
206	LAUNDRY	LVT	VB	PT			FACTORY	APC	
207	BEDROOM	VP-1	VB	PT			FACTORY	APC	
207A	BATH	CT-1	CT-1	PT			PT	GB	
208	BEDROOM	VP-1	VB	PT			FACTORY	APC	
208A	BATH	CT-1	CT-1	PT			PT	GB	
209	BEDROOM	CPT-4	VB	PT			FACTORY	APC	
209A	BATH	CT-1	CT-1	PT			PT	GB	
210	BEDROOM	CPT-4	VB	PT			FACTORY	APC	
210A	BATH	CT-1	CT-1	PT			PT	GB	
211	VISITOR'S LOUNGE	CPT-1	VB	PT			FACTORY	APC	
212	COMPUTER ROOM	CPT-1	VB	PT			FACTORY	APC	
213	BEDROOM	CPT-4	VB	PT			FACTORY		